


## WATER CERTIFICATE OF AVAILABILITY

Lakehaven Water & Sewer District – Development Engineering Section 31623 – 1st Ave S \* PO Box 4249 \* Federal Way, WA 98063-4249

Email: DE@Lakehaven.org \* Telephone: 253-945-1581 or 253-945-1580

ini dis	form scre	ation tion, r	necess eserve	sary to eva s the right	aluate developmen	t proposals. Lakehaven Wat , water service based upon c	public health departments with er & Sewer District, at its sole apacity &/or supply limitations	
Proposed Land Use:		Subdiv	ng Permit-SFR () vision () lary Line Adjustment	<ul><li>☑ Building Permit-MFR (345)</li><li>☐ Short Subdivision ()</li><li>☐ Other (specify/describe)</li></ul>	☐ Building Permit-Other ☐ Binding Site Plan			
Tax	k Par	cel Num	ber(s):	172104-9019	9 <u>, -9028, -9030, -9031</u>	<u>, -9033, -9034, -9035, -9046, -9051</u>	., -9057, -9059, -9064, -9074, 9090	
Site Address: <u>330XX - 13th Ave S</u>			13th Ave S	LWSD GIS Grid: <u>J-10</u>				
Ex.	Bldg	. Area t	o Rema	in: <u>N/A sf</u>	New Bldg. Are	New Bldg. Area Proposed: 593,700 sf (total, 2 MFR bldgs) + Rec. Bldg.		
W	ATER	SYSTE	M INFO	RMATION				
1.				can be prov	vided by service conne	ection to an existing diamet	ter water main that is approximately	
<ol> <li>3.</li> <li>4.</li> <li>5.</li> </ol>	$\boxtimes$	a. b. c. d. a. b. a. b. er servia. b.	5+/- The c A may const Other diame The e Amen The s Bounc Annes Ence is su Paym Proof	feet of 8" & 1 construction of portion of ructed; and/o (describe): Jeter will likely xisting water xisting water dment to this ubject proper dary Review I cation or Bou bject to: ent of connector reservatio	12" diameter water main a water distribution so LWSD's comprehensive or LWSD Developer Extendated by the required.  To system is in conformated by the required of the required of the required of the water water water approval for extendary Review Board approtection charges (to be detent of easement(s) as resultant of the result	quired by LWSD;	ter System Plan. Water System Plan and an of land use approvals or permits. er District, or has been granted SD's water service area.	
_	$\boxtimes$	C.			<u> </u>	must be accepted by LWSD, prior to	service connection activation(s).	
				itions:				
Fire Thi	Flov flov	v at no v figure than thi	less that depicts s may b	n 20 psi ava the theoreti e accommod	ilable within the water cal performance of the ated through water dis	water distribution system under high	2,500 GPM for two (2) hours or more. If demand conditions. Fire flow rates fact LWSD for additional information.  It Meter(s) (psi): 53-61	
	ereby natur		that th	e above wate	er system information	is true. This certification shall be va	alid for one (1) year from the date of	
	me: <u>E</u> natur	e:	SBURY	- A	Title: DEVELOPMENT EN	GINEERING SUPERVISOR	Date: 5/23/19	

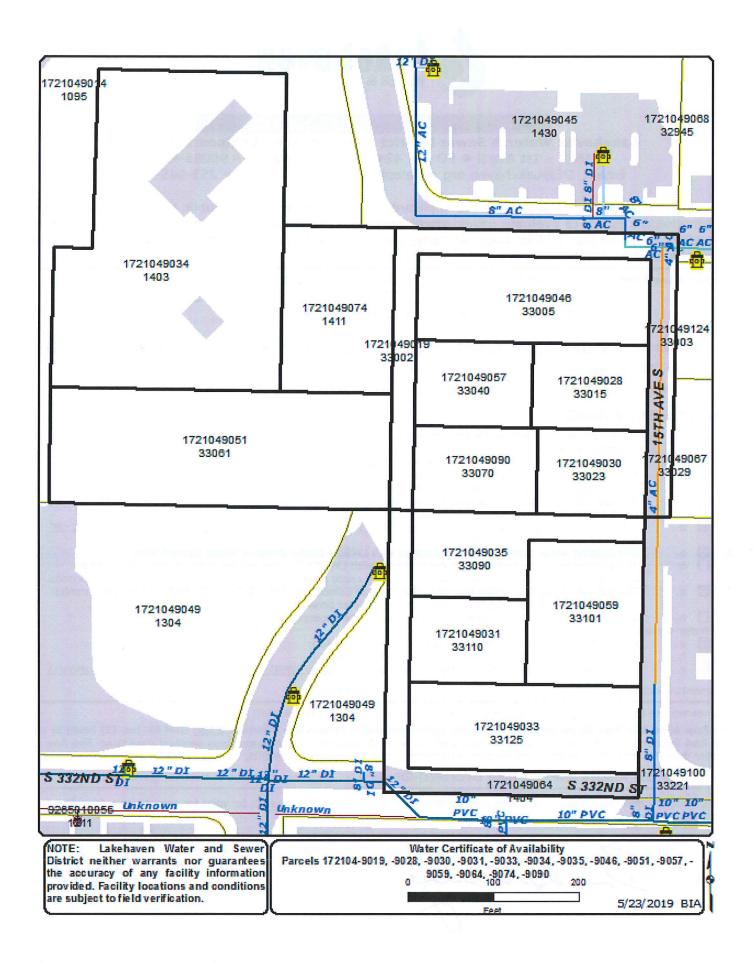




#### SEWER CERTIFICATE OF AVAILABILITY

Lakehaven Water & Sewer District - Development Engineering Section

31623 – 1st Ave S \* PO Box 4249 \* Federal Way, WA 98063-4249 Telephone: 253-945-1581 or 253-945-1580 \* Email: DE@Lakehaven.org

This certificate is intended to provide the applicant, land use agencies &/or public health departments with information necessary to evaluate development proposals. Lakehaven Water & Sewer District, at its sole discretion, reserves the right to delay, or deny, sewer service based upon capacity &/or supply limitations in Lakehaven's or Other Purveyor's system facilities.

Proposed Land Use:	☐ Building Permit-SFR () ☐ Subdivision ()		☑ Building Permit-MFR (345 ☐ Short Subdivision ()	) ☐ Building Permit-Other☐ Binding Site Plan
	Boundary Line	Adjustment	Other (specify/describe) _	_
Tay Parcel Number(s)	172104 0010 0029	0020 0021	0022 0024 0025 0046 0	9051, -9057, -9059, -9064, -9074, 9090
				<u>1031, -9037, -9039, -9004, -9074, 9090</u>
Site Address: 330XX – 1		LWSD GIS Grid		
Ex. Bldg. Area to Remai	n: <u>N/A sf</u>	New Bldg. Area Proposed: <u>593,700 sf (total, 2 MFR bldgs) + Rec. Bldg.</u>		
SEWER SYSTEM INFO	RMATION			
approximately 2.	feet from the solution for the site will required to the site will required to the solution of a sanitation of	site and the se te an improven twer main or tr ary sewer colle	on to an existing diamet ewer system has the capacity to s nent to LWSD's sanitary sewer sy runk to reach the site; and/or action system on the site; and/or e wastewater system plan would	serve the proposed land use. ystem of:
<ul> <li>☑ d. Other</li> <li>3. ☑ a. The expension</li> <li>☑ b. The expension</li> <li>4. ☒ a. The properties</li> </ul>	(describe): <u>LWSD Developer Extension (DE) Agreement required</u> .  xisting sewer system is in conformance with LWSD's Comprehensive Wastewater System Plan.  xisting sewer system is not in conformance with LWSD's Comprehensive Wastewater System Plan and an an adment to this Plan will be required. This may cause a delay in issuance of land use approvals or permits. Toposed site land use is within the corporate limits of Lakehaven Water & Sewer District, or has been grante			
<ul><li>□ b. Annex</li><li>Sewer service is sul</li><li>□ a. Payme</li><li>□ b. Proof of</li></ul>	ation or Boundary Re oject to: ent of connection chai or reservation of ease	eview Board ap rges (to be det ement(s) as re	quired by LWSD;	
Comments/special cond	tions:			
I hereby certify that the signature.	e above sewer syster	n information	is true. This certification shall b	pe valid for one (1) year from the date of
Name: BRIAN ASBURY	Title: DEV	/ELOPMENT EN	IGINEERING SUPERVISOR	
Signature:	Asle	ny		Date: 5/23/19
		f		

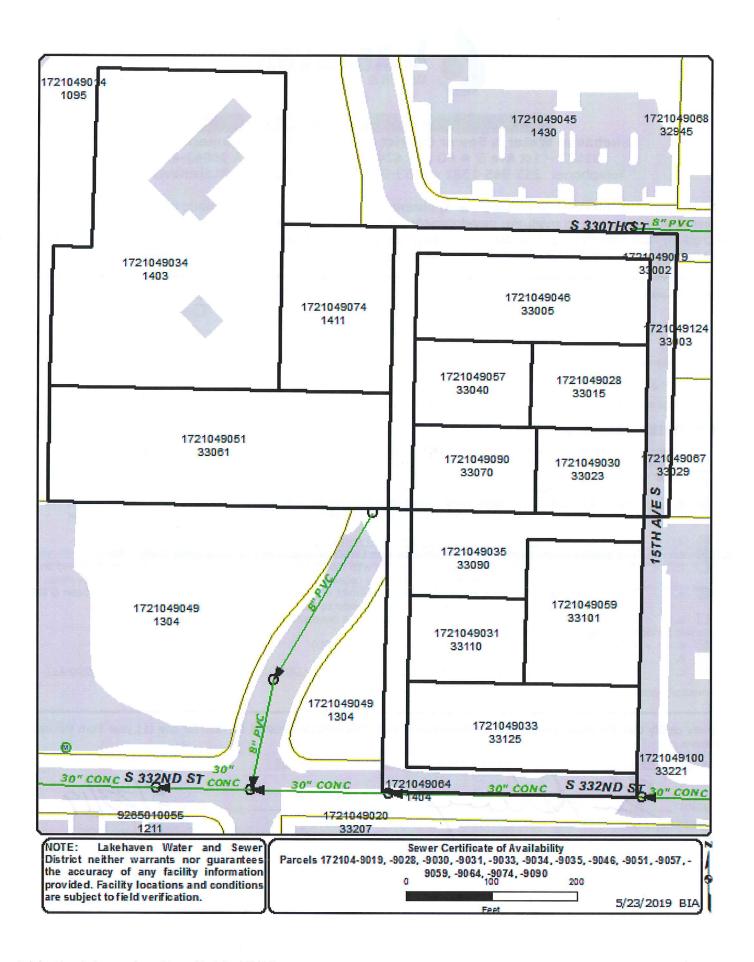



# Hydraulic Model Fire Flow Estimate Request/Reporting Form

Requested By:	Date:		
Dawn Zern	5/22/19		
Location to be Modeled: Existing Hydrant near Parcel # 1721049046			
Lakehaven ¼ Section Grid:	J/10		
Intersection:	S 330 <sup>th</sup> St & 15 <sup>th</sup> Ave S		
Add. Description:	See attached map	Pressure Zone: 538	


Results By:	Date:	Model Run No.:
John Bowman	5/28/19	Master Water System Model 2007.net <b>FF #360</b>
Condition	Pressure (psi)	Flow (gpm)
Static	43	0
Fire Flow	20	3500

#### NOTES:

Lakehaven's adopted level of service goals for fire flow rates are 1000 gpm within single family residential areas (including duplexes) and 2500 gpm for multi-family, commercial, industrial areas.

Model results depict the theoretical performance of the water system under high demand conditions and are not guaranteed to represent actual system performance. A design professional should be consulted for site specific design purposes.

The calculated fire flow capacity in the above table is based on a currently available residual system pressure of 20 psi at the location modeled. The model indicates that Lakehaven's standard maximum allowable velocity of 10 ft/s is exceeded at a fire flow rate above 1600 gpm. Fire flow capacities greater than 1600 gpm may be accommodated through water system improvements.

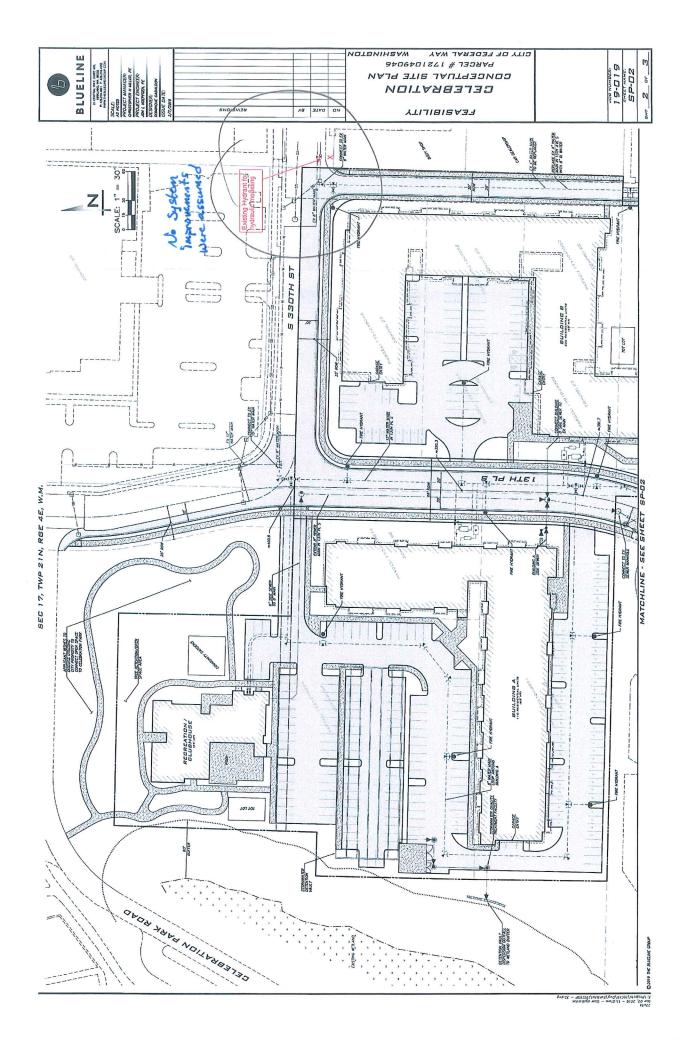



# REQUEST FOR WATER HYDRAULIC MODEL ANALYSIS REPORT

To:	Lakehaven Water & Sewer District
	Attn: Development Engineering
	31623 – 1st Ave S
	PO Box 4249

Federal Way WA 98063-4249

FOR LAKEHAVEN USE ONLY

Fee: \$230.00

Paid Date: 5/21/19

Receipt No. 386617

I would like to request a water hydraulic model (aka 'fire flow') analysis & report for the following location:

Parcel Number

1721049046


Site Address

33005 15th Ave S. Federal Way 98003

### \* \* INCLUDE A MAP OF, OR INDICATE, HYDRANT(S) DESIRED TO BE MODELED \* \*

Jake Drake
Name of Authorized Representative/Contact
Permitting Technician
Title/Position
425-250-7232
Contact Telephone Number
jdrake@thebluelinegroup.com
Contact Email
05/20/2019
Date

SKF requests
3809 gpm

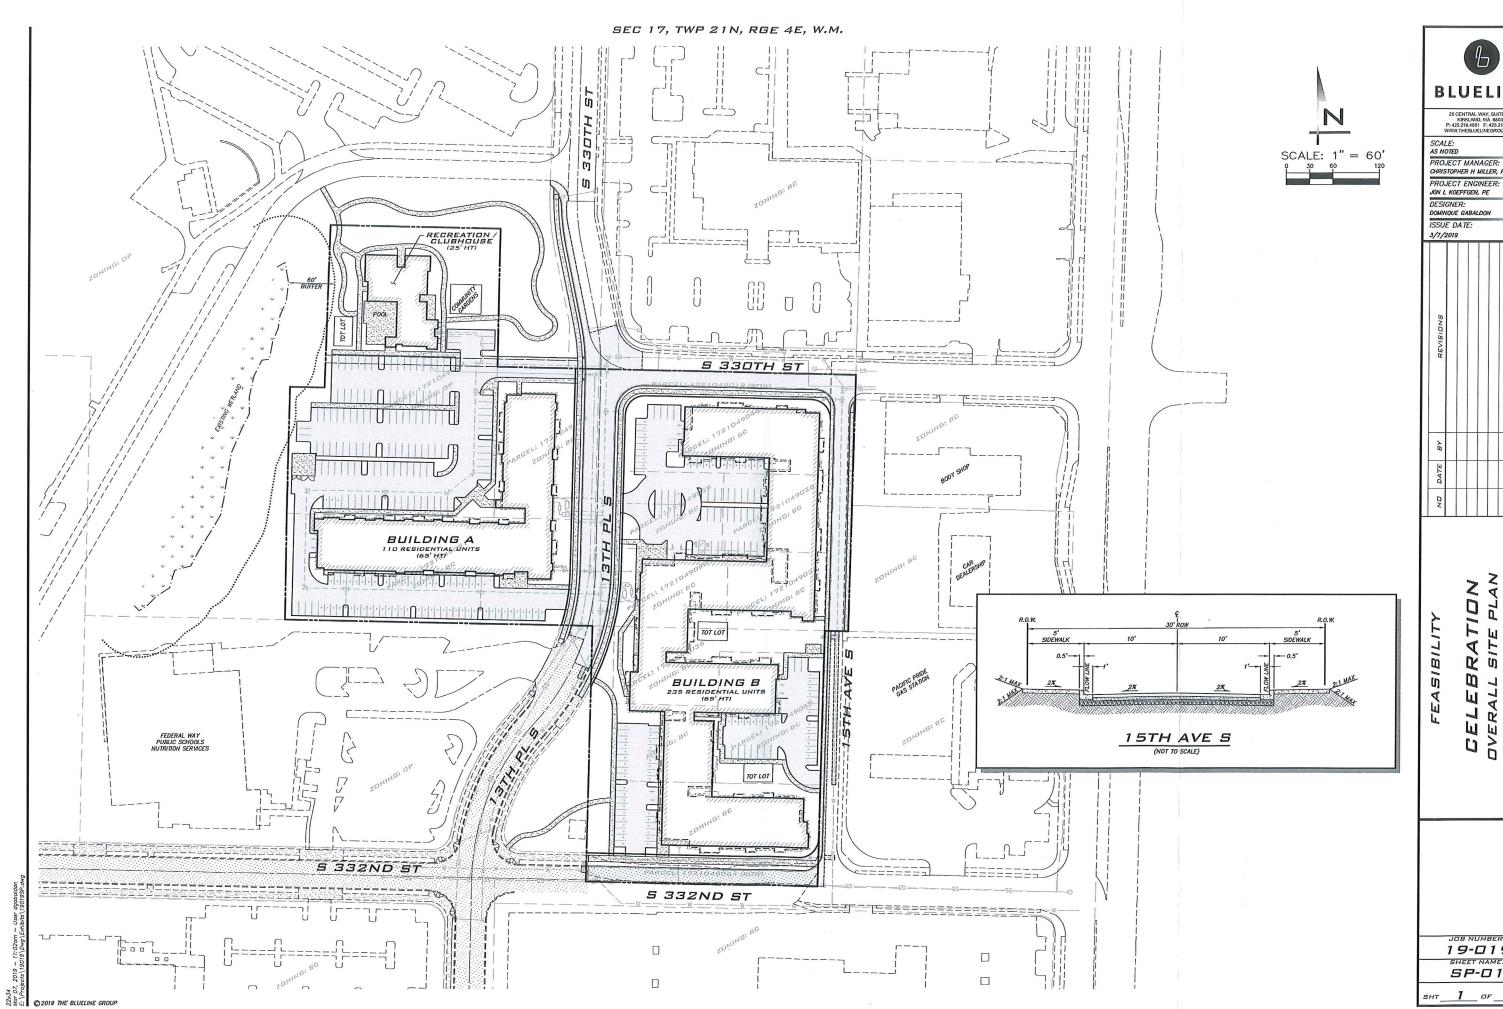

6 BLUELINE

25 CENTRAL WAY, SUITE 400, KIRKLAND, WA 98033 P:425.216.4051 F:425.216.4052 WWW.THEBLUELINEGROUP.COM

SCALE: AS NOTED PROJECT MANAGER: CHRISTOPHER H MILLER, PE


DESIGNER: DOMINQUE GABALDON

ISSUE DATE:


-EBRATION ALL SITE PLAN EL# 1721049046 RAL WAY WASHIN CELEBI OVERALL: PARGEL# 1


JOB NUMBER: 19-019 SHEET NAME: SP-01

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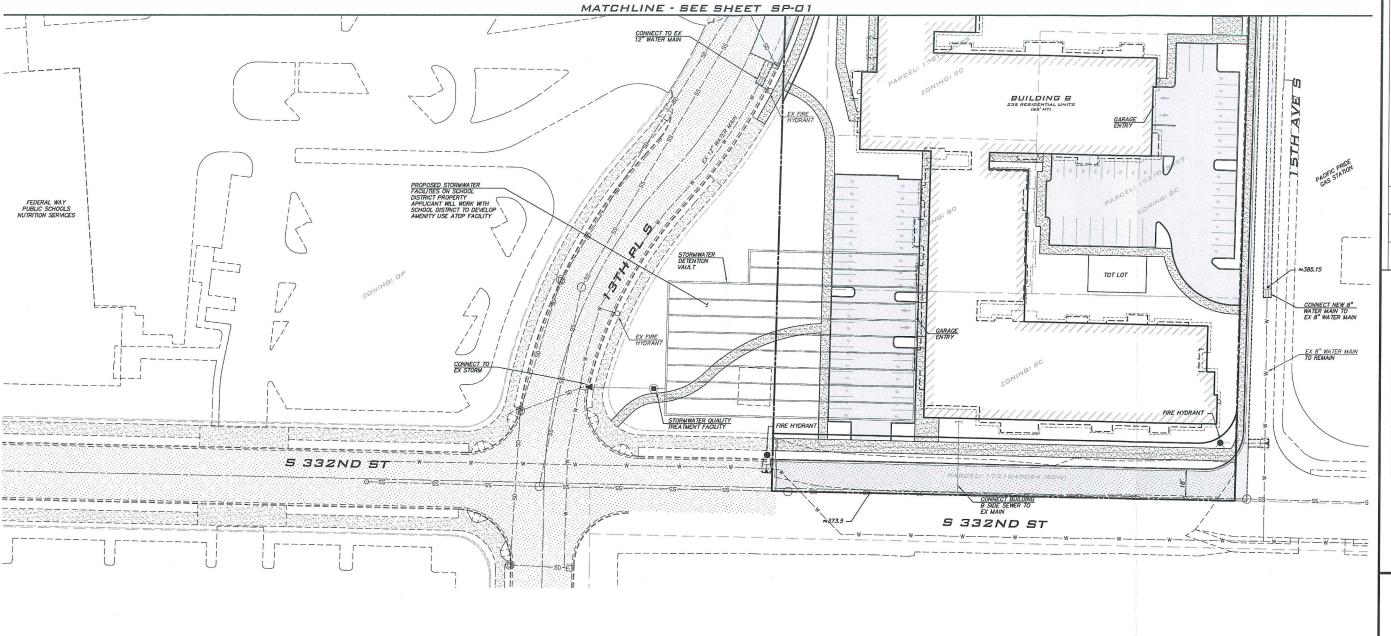


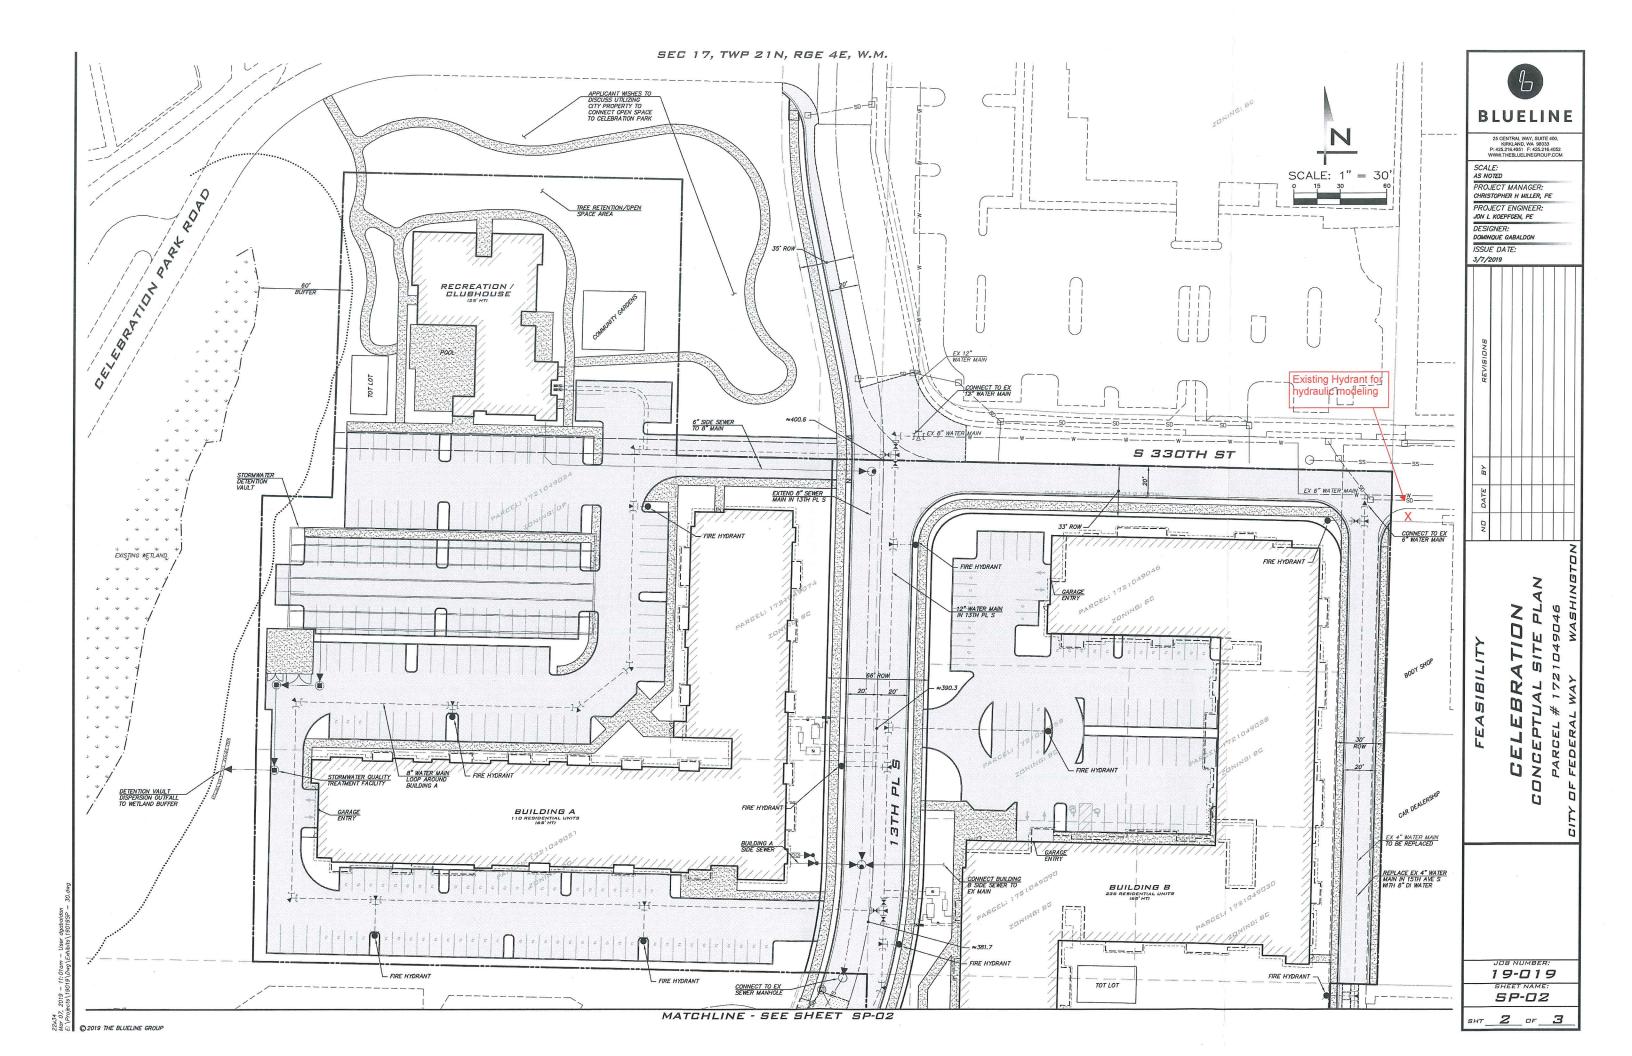19-019 SHEET NAME: SP-03

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BLUELINE

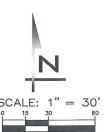SCALE: AS NOTED

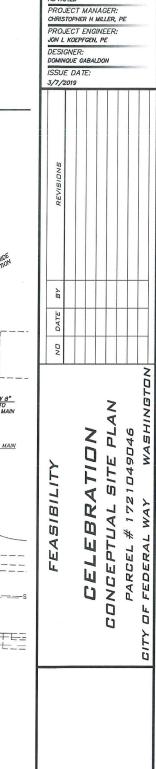

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