

KITCHEN & SERVERY - FLOOR PLAN

	<u>U k</u>	IPMENT SCHE	Furnished		<u>ں پہ</u>	IPMENT SCHE	Furnished
tem No	Qty	Description	by:	Item No	Qty	Description	by:
1	1	MOP SINK CABINET		35	1	SST COUNTER	
2	1	WATER FILTER		36	1	TYPE 1 HOOD/ DCV CABINET	
3	1	ICE MACHINE HEAD		37	1	MUA BOX	
4	1	ICE BIN		38	1	FRYER UNIT W/ FILTRATION	
5	1	FLOOR TROUGH		39	1	GRIDDLE	
3	LOT	DRY STORAGE SHELVING		40	1	CHAR-BROILER	
7	-	SPARE NUMBER		41	1	SPREADER PLATE	
3	-	SPARE NUMBER		42	1	6 BURNER RANGE	
9	-	SPARE NUMBER		43	2	DBL. STK. COMBI OVEN	
10	LOT	FREEZER SHELVING		44	1	ROLL-IN REFRIGERATOR	
11	1	FREEZER COIL		45	1	DROP-IN HAND SINK	
12	1	WALK-IN FREEZER		46	1	UNDER COUNTER FREEZER	
13	LOT	COOLER SHELVING		47	1	FIRE PROTECTION SYSTEM	
14	1	COOLER COIL		48	1	S/S WALL FLASHING	
15	1	WALK-IN COOLER		49	1	MOBILE POT & PAN UNIT	
16	1	REMOTE REFER RACK SYS.		50	1	MOBILE POT & PAN UNIT	
17	4	MOBILE PAN RACKS		51	1	MOBILE HEATED PLATE DISP.	
18	5	SLIM JIM TRASH CAN		52	1	MOBILE HEATED PLATE DISP.	
19	1	DROP-IN HAND SINK		53	1	MOBILE HEATED CABINET	
20	1	SST WALL CABINET		54	1	MOBILE HEATED CABINET	
21	1	PRE-RINSE UNIT		55	1	MOBILE HEATED CABINET	
22	1	SST WALL CABINET		56	1	SECURED LIQUOR STORAGE	
23	1	PRE-RINSE UNIT		57	1	DIRTY DISH TABLE	
24	1	SST WALL CABINET		58	1	WASTE COLLECTOR	
25	1	SST PREP COUNTER		59	1	PRE-RINSE UNIT	
26	1	ROLL-IN REFRIGERATOR		60	1	CONVEYOR DISH WASHER	
27	1	BLAST CHILLER		61	1	TYPE 2 HOOD	
28	3	HEAT LAMPS		62	1	CLEAN DISH TABLE W/ 3 SINKS	
29	1	HEATED DIPPER WELL		63	1	SST OVER SHELF	
30	1	CHEF'S COUNTER		64	1	HOSE REEL ASSEMBLY	
31	1	DROP-IN HOT WELLS		65	1	POT FILLER	
32	1	SST COUNTER		66	1	HAND SINK	
33	2	SST OVER SHELF		67	1	BEVERAGE COUNTER	
34	1	PIZZA PREP STATION		68	1	ICE & WATER STATION	
				69	2	OVER SHELF	
				70	1	COFFEE BREWER (FUTURE)	
		CODE SECTIONS C402.5 C402.6		71	1	AIR CURTAIN (W/ PLUNGER)	

COMPLIANCE WITH 2012 WASHINGTON STATE ENERGY CODE, SECTIONS C402.5, C402.6, & C403.5

K-FACTOR - .1378 FOR COOLERS / .1232 FOR FREEZERS
U-FACTOR - 7.257 FOR COOLERS / 8.117 FOR FREEZERS
4" PANEL R-FACTOR - 29.03 FOR COOLERS / 32.47 FOR FREEZERS
5" PANEL R-FACTOR - 36.29 FOR COOLERS (WALLS AND ROOFS) / 40.59 FOR FREEZERS (WALLS AND ROOFS)
FREEZER FLOOR INSULATION R-FACTOR - 32.47 / INSULATED FREEZER SLAB R-FACTOR - 28.0 HINGED DOORS TO INCLUDE DOOR CLOSER, STRIP CURTAINS, AND A PRE-SET ANTI-SWEAT DOOR FRAME HEATER WIRE TRIPLE-PANE GLASS WINDOWS SPRING-LOADED HINGES, 42" WIDE DOORS & BELOW / SPRING ACTION HEAVY DUTY DOOR CLOSER, DOORS WIDER THAN 42"

NOTE:

PUBLIC HEALTH - SEATTLE & KING COUNTY INSPECTION REQUIRED ON COMPLETION OF WORK PRIOR TO OPENING.

NO CHANGES WILL BE MADE WITHOUT HEALTH DEPARTMENT APPROVAL.

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FEDERAL WAY PERFORMING ARTS & EVENTS CENTER


Drawn Checked GEL

14 AUGUST 2015

Floor Plan and Schedule

Sheet Number

Submittal

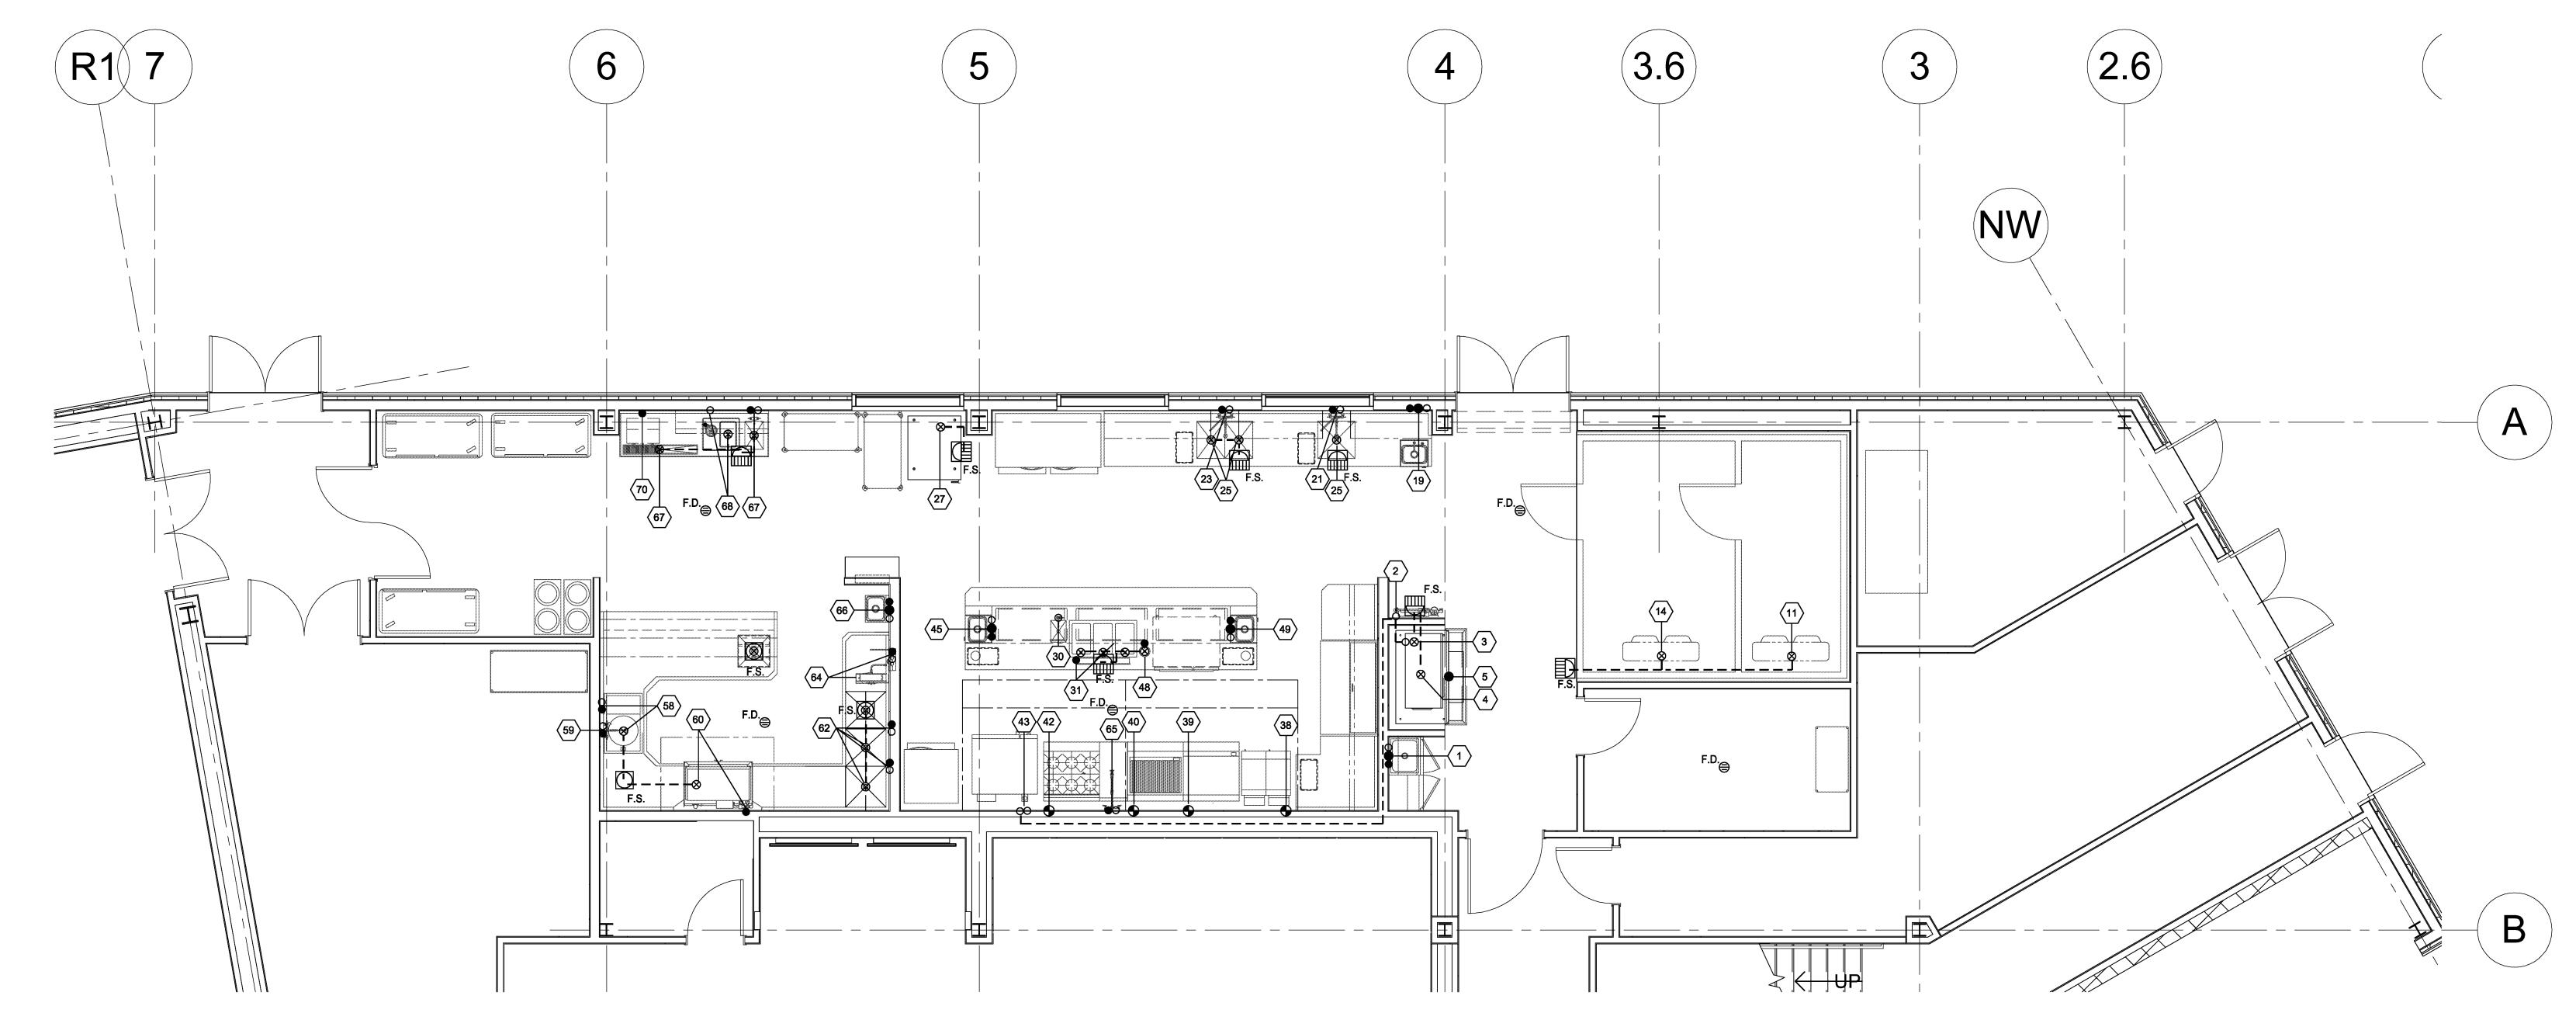

KITCHEN & SERVERY - PLUMBING REQUIREMENT PLAN

			. E	E Q	UI	P M	EN	I T	S C	HE	DU	J L E	-	
Item No	Qty	DESCRIPTION	Cold Water Size (in)	Cold Water AFF (in)	Hot Water Size (in)	Hot Water AFF (in)	Direct Drain Size (in)	Direct Drain AFF (in)	Indir Drain Size (in)	Indir Drain AFF (in)	Gas Size (in)	MBTUH	Gas AFF (in)	Remarks
1	1	MOP SINK CABINET	1/2	36	1/2	36	2	3						
2	1	WATER FILTER	1/2	66										RUN CW TO ITEM 3 - ICE MACHINE
3	1	ICE MACHINE HEAD							1/2	F.S.				CW WATER FROM ITEM 2 - WATER FILTER
4	1	ICE BIN							3/4	F.S.				
5	1	FLOOR TROUGH					3	-11						
11	1	FREEZER COIL							3/4	F.S.				
14	1	COOLER COIL							3/4	F.S.				
19	1	DROP-IN HAND SINK	1/2	12	1/2	12	1-1/2	16						
21	1	PRE-RINSE UNIT	1/2	18	1/2	18								
23	1	PRE-RINSE UNIT	1/2	18	1/2	18								
25	1	SST PREP COUNTER							(3) 2	F.S.				
27	1	BLAST CHILLER							1-1/4	F.S.				
30	1	CHEF COUNTER (SINK)	1/2	8					1/2	F.S.				
31		DROP-IN HOT WELLS	1/2	8					1/2	F.S.				
38	1	FRYER UNIT W/ FILTRATION									3/4	180	14	
39	1	GRIDDLE									3/4	185	30	
40	1	CHAR-BROILER									3/4	90	60	
12	1	6 BURNER RANGE									3/4	210	30	
43	1	DBL. STK. COMBI OVEN	(2) 1/2 (2) 1/2						(2) 2	F.S.				RUN CW FROM ITEM 2 - WATER FILTER 2" STEAM VENT PIPE (EA.)
15	1	DROP-IN HAND SINK	1/2	8	1/2	8	1-1/2	8						
18	1	HEATED DISHER WELL			1/2	8			3/4	F.S.				
58	1	WASTE COLLECTOR	1/2	18	1/2	18			2	F.S.				
59	1	PRE-RINSE UNIT	1/2	18	1/2	18								
30	1	CONVEYOR DISH WASHER			1/2	18			2	F.S.				
52	1	CLEAN DISH TABLE W/ 3 SINKS	(2) 1/2	18	(2) 1/2	18			(3) 2	F.S.				
64	1	HOSE REEL ASSEMBLY	1/2	54	1/2	54								
35	1	POT FILLER	1/2	54	1/2	54								
66	1	HAND SINK	1/2	12	1/2	12	1-1/2	16						
 67	1	BEVERAGE COUNTER	1/2	12	1/2	12			(2) 2	F.S.				
88	1	ICE & WATER STATION	1/2	12					1	F.S.				
'0	1	COFFEE MAKER (FUTURE)			1/2	54								FOR FUTURE USE

PLUMBING REQUIREMENTS NOTES

- This drawing is for foodservice equipment only. Refer to architects and engineering drawings for other systems and equipment requirements.
- 2. This drawing is not to be used for establishing rough-in locations. Refer to dimensioned rough-in drawings prepared by the kitchen equipment contractor.
- 3. All utility lines shall be concealed in walls and columns unless noted otherwise.
- 4. All floor sinks and floor drains indicated shall be flush with finished floor.
- Plumbing Division 22, to furnish, install, or interconnect the following:
- Make all rough-in and final connections for water, drains, steam, and gas in conformance 6. Furnish and install all sink waste lines. Include traps, and tailpieces, as required.

All hot water is to be supplied to kitchens at 120-degree F unless noted otherwise on drawings. Furnish and install supply shut-off valves with permanent identifying name tags

possible between hot and cold water systems. Such as, but not limited to pre- rinse sprays,

- on each supply line to each piece of equipment. Install and connect equipment faucets and vacuum breakers provided by the kitchen
- equipment contractor under Division 11. 9. Furnish and install check valves on hot and cold water lines where an open circuit is

conform with local codes.

- hose reels, pot fillers, kettle fillers, hose bibb faucets and electronic hand sink faucets. 10. Furnish and install reduced pressure backflow devices on all water supply lines. To
- 11. Furnish and install all interconnecting piping between hoods, control panels, and fire protection control panels. Also between dishwashers and booster heaters, waste pulpers
- 12. Interconnect all component parts or sections of equipment not pre-plumbed by the manufacturer and all equipment delivered in sections.
- 13. Furnish all indirect drains from equipment to floor sinks. All lines from ice bins shall be
- 14. Furnish and install drain lines and traps from cold storage room evaporators to floor sinks. The kitchen equipment contractor, under Division 11, shall provide and install heat tape on the freezer drain lines. 15. Furnish and install gas and water pressure reducing valves as required. Maximum water
- pressure at warewashing, pot washers, and booster heaters shall be 20 p.s.i.. Verify gas pressure at each appliance.
- 16. Install mechanical shut-off valves provided by the Fire Protection Contractor on the primary gas supply to each cooking line to shut down gas fired cooking equipment during fire system activation. Provide 120v power connection by electrician if electrical gas solenoid
- 17. Grease trap size and location is provided under plumbing work Division 22, and not part of
- 18. For additional information regarding food service equipment and /or type/ method of utility connection refer to the manufacturer's specification sheets in the "Food Service
- Equipment Brochures" package provided for this project. 19. See plumbing and mechanical drawings for additional requirements.

 HOT WATER (HW) O COLD WATER (CW) DIRECT WASTE ⊗ INDIRECT WASTE (I.W.)

FLOOR SINK W/ HALF GRATE (F.S.)

PLUMBING LEGEND

GAS SUPPLY LINE RUN & CONNECTION BY PLUMBING CONTRACTOR LINE RUN FROM I.W. TO F.S. BY PLUMBING CONTRACTOR FLOOR DRAIN (F.D.) FLOOR SINK (F.S.)

FUNNEL FLOOR DRAIN (F.F.D.)

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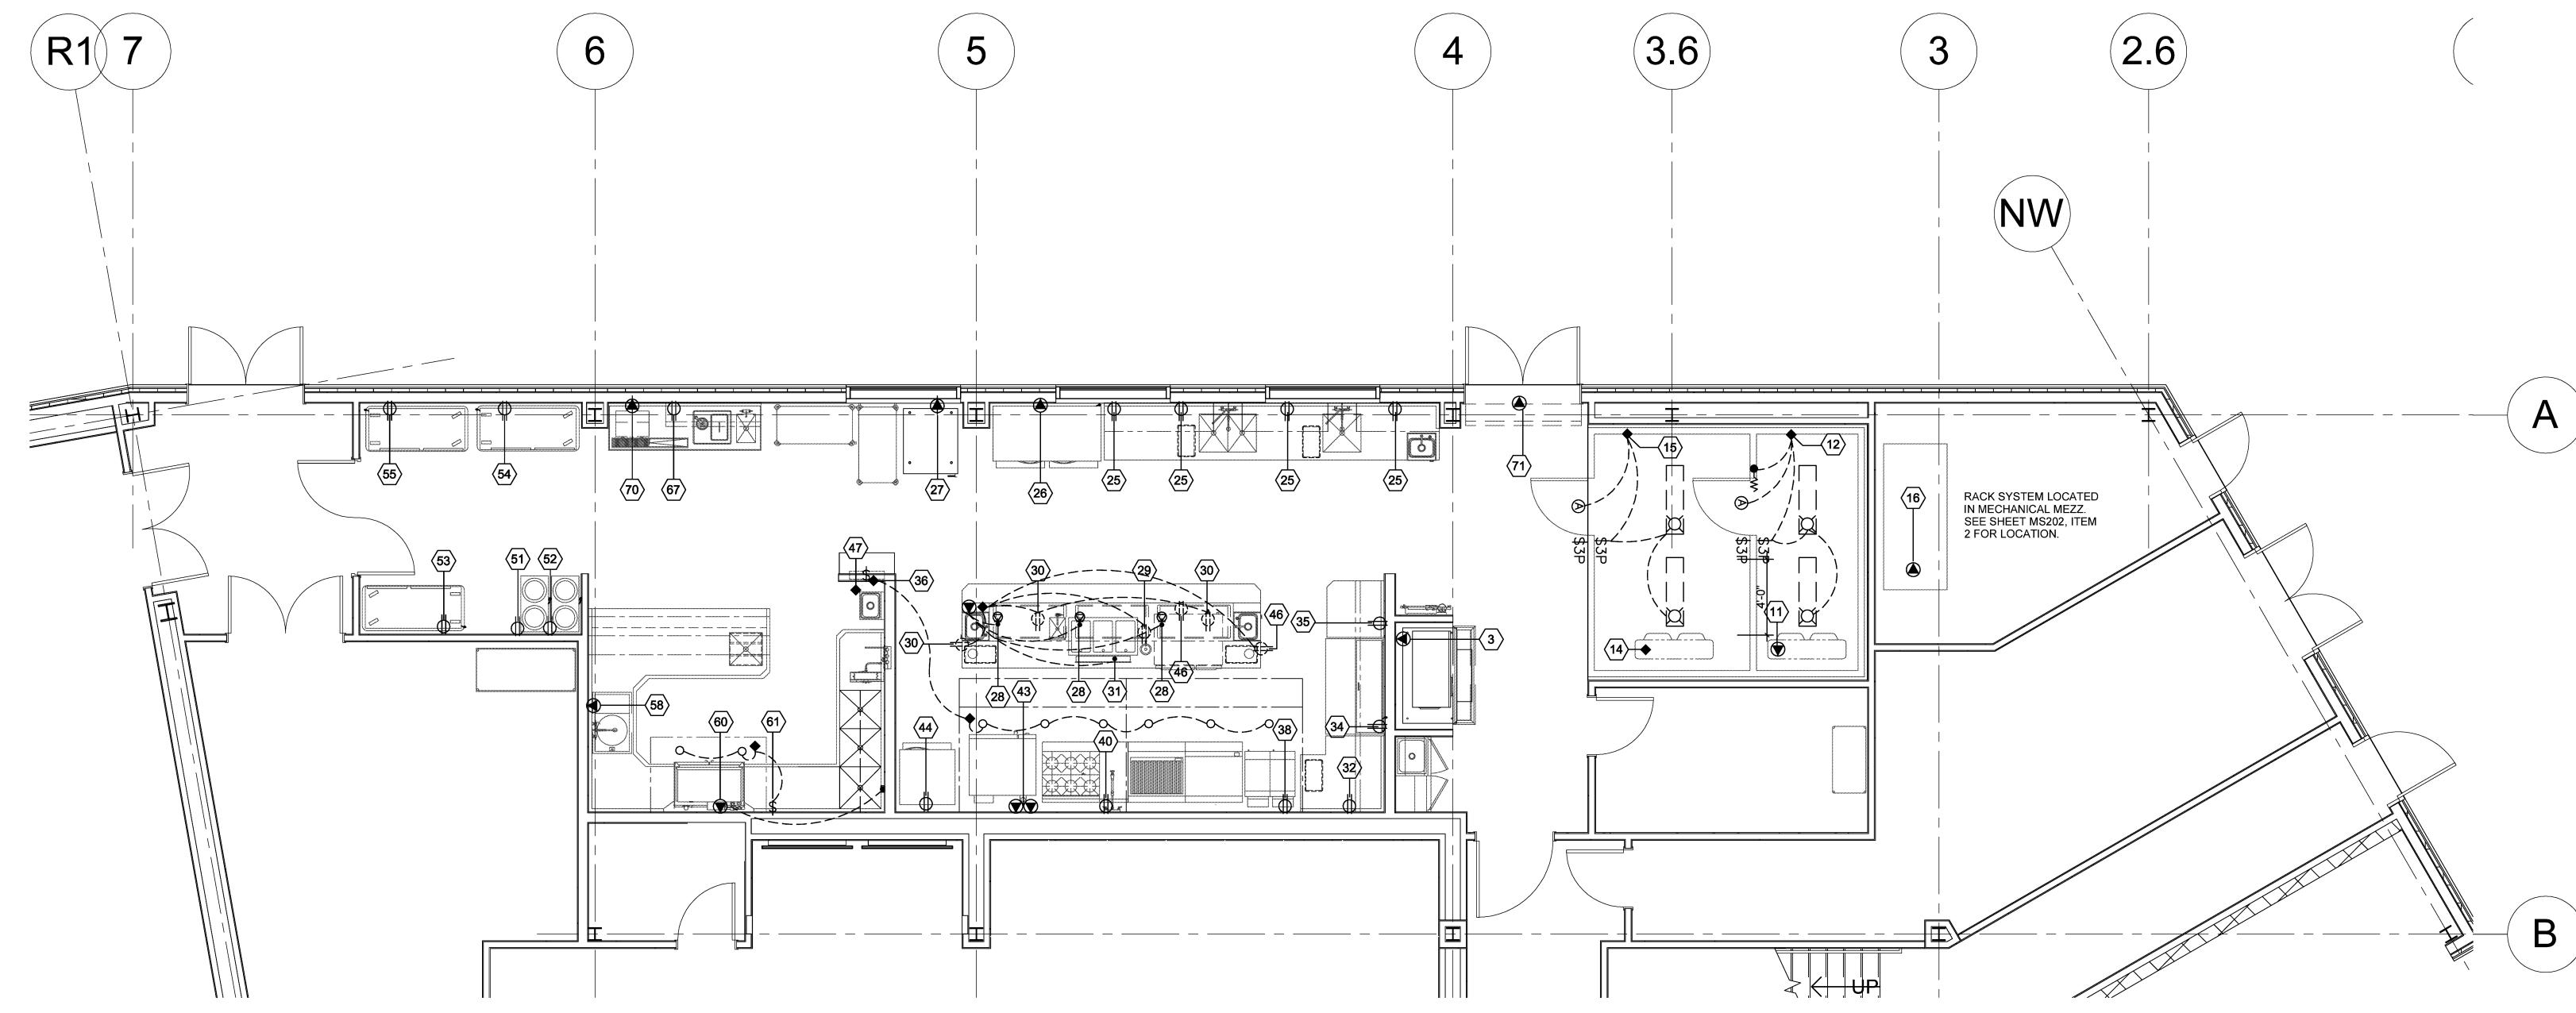
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Plumbing Requirement



KITCHEN & SERVERY - ELECTRICAL REQUIREMENT PLAN

EQUIPMENT SCHEDULE													
Item No	Qtv	Description	Volts	Phase	Amps	KW	윺	Cycle	Direct	Plug	NEMA	Electrical AFF (in)	Electrical Remarks
3	1	ICE MACHINE HEAD	208	3	13.2			60	Х			95	
11	1	FREEZER COIL	208	1	11.5			60	Х			DFA	
12	1	WALK-IN FREEZER	120	1		0.4		60	Х			DFA	
14	1	COOLER COIL	120	1	1.8			60	Х			DFA	
15	1	WALK-IN COOLER	120	1		0.8		60	Х			DFA	
16	1	REMOTE REFER RACK SYS.	208	3	55			60	Х				
25	1	SST PREP COUNTER	(4) 120	1				60	Х			48	FOUR (4) D.C.O's MOUNTED ABOVE BACKSPLASH
26	1	ROLL-IN REFRIGERATOR	120/208	1	14.4			60	Х			84	
27	1	BLAST CHILLER	208	3	26.5			60		Х	L15-30P	14	
28	3	HEAT LAMP	120/240	1		1		60	Х			8	RUN TO FIXTURE MOUNTED REMOTE CONTROLS.
29	1	HEATED DISHER WELL	120	1	2.8			60		Х	5-15P	8	RUN TO FIXTURE MOUNTED OUTLET.
30	1	CHEF'S COUNTER	(4) 120	1				60	Х			8	TWO (2) D.C.O's FIXTURE MOUNTED OUTLETS.
31	1	DROP-IN HOT WELLS	208	3	11.9			60	Х			8	RUN TO FIXTURE MOUNTED CONTROL.
32	1	SST COUNTER	(2) 120	1				60	Х			48	TWO (2) D.C.O's MOUNTED ABOVE BACKSPLASH
34	1	PIZZA PREP STATION	120	1	13.0			60		Х		14	
35	1	SST COUNTER	120	1				60	Х			48	TWO (2) D.C.O's MOUNTED ABOVE BACKSPLASH
36	1	TYPE 1 HOOD	(2) 120	1	25			60	Х			DFA	WIRE TO WALL MOUNT DCV CABINET. SEE FS601 & 604
38	1	FRYER UNIT W/ FILTRATION	120	1	8.5			60		Х		14	
40	1	CHAR-BROILER (REFER BASE)	120	1	12.6			60		Х	5-15P	36	
43	1	DBL. STK. COMBI OVEN	(2) 480	3	52 / 31			60	Х			24/66	
44	1	ROLL-IN REFRIGERATOR	120	1	11.4			60		Х		84	
46	1	UNDER COUNTER FREEZER	120	1	6.1			60		Х		8	RUN TO FIXTURE MOUNTED OUTLET.
47	1	FIRE PROTECTION SYSTEM	120	1	20.0			60	Х			DFA	SEE SHEET FS603 FOR FIRE SYSTEM DETAILS.
51	1	MOBILE HEATED PLATE DISP.	120	1	11.0			60		Х	5-20P	14	
52	1	MOBILE HEATED PLATE DISP.	120	1	11.0			60		Х	5-20P	14	
53	1	MOBILE HEATED CABINET	120	1	16.7			60		Х	5-20P	14	
54	1	MOBILE HEATED CABINET	120	1	16.7			60		Х	5-20P	14	
55	1	MOBILE HEATED CABINET	120	1	16.7			60		Х	5-20P	14	
58	1	WASTE COLLECTOR	208	3	3.2			60	Х			24	
60	1	CONVEYOR DISH WASHER	480	3	27.4			60	Х			64	CONNECTION FOR CONTROLS, TANK HEAT & TBL. LIMIT SW.
	'	ON THE PORT OF BIOTH WASHIER	480	3	40			60	Х			64	CONNECTION FOR BOOSTER HEATER.

60 X

60 X

208 | 1 | 25

120 | 1 | 3.4

- 1. This drawing is for food service equipment only. Refer to architects and engineering drawings for other systems and equipment requirements. 2. This drawing is not to be used for establishing rough-in locations. Refer to dimensioned rough-in
- shop drawings prepared by the kitchen equipment contractor. 3. All electrical lines shall be concealed from sight in walls and columns unless noted otherwise.
- Electrical Division 26, to furnish, install, or interconnect the following:
- breaker panels, or switches etc. in conformance with local codes. 5. All electrical rough-ins, wiring to connections, interconnections and final connections shall be provided and performed by the Electrical Contractor in compliance with applicable national, state,

4. Provide all rough-ins, interconnecting wiring and final connections to controls, receptacles, J-boxes,

- and local codes. 6. Furnish and install all disconnects, interlocks, and contactors required by governing codes. These are not provided as part of food service equipment.
- 7. All electrical receptacles shall be provided with stainless steel faceplates mounted horizontally on fixtures and walls.
- 8. All floor outlets and electrical pedestals shall be waterproof.
- 9. Provide installation switches, controls, and all interconnecting wiring to ventilator lights and ventilator fan on/off switches furnished with equipment under kitchen equipment Division 11.
- 10. Furnish and install interconnecting control wiring and conduit between fire protection control panels, ventilators, and gas solenoid valve to shut down cooking equip- ment during fire system activation. 11. Provide wiring and conduit to interconnect: From ventilator control cabinet to main thermostat
- J-box on ventilator. From control cabinet to remote fire switch. From control cabinet to remote solenoid valves, from control cabinet to magnetic start switch.
- 12. Furnish and install shunt trip circuit breakers to shut down power supply to all electrical service under the ventilators during fire system activation.
- 13. Furnish 120v circuit, wiring, and conduit from terminal block inside fire protection control cabinet to UL approved solenoid gas valve installed by the plumber.
- 14. Furnish and install for walk-in cold storage rooms all interconnecting conduit and wiring concealed from sight on top of cold storage room. Cold storage room lights, switches, temperature alarms, thermostats furnished by kitchen contractor for installation by electrician. Ceiling mounted evaporators installed under kitchen equipment, Division 11.
- 15. All evaporator motor connections shall be made with conduit to a J-box connection. Plug-in type connections will not be acceptable.
- 16. Furnish and install "EYS" and foam insulation to properly seal-off all pentrations of cold stage room
- 17. The kitchen contractor Under Division 11 will furnish and install heat tape on freezer drain lines. 18. Furnish and install conduit, cable, connectors and junction boxes for communication cable adjacent to a clean circuit convenience outlet for the on-line-point-of-sale food & beverage control system. Verify manufacturer and system requirements with operator.
- 19. See electrical engineers drawings for additional information.
- 20. For additional information regarding food service equipment and/or type/method of utitlity connection refer to the manufacture's specification sheets in the "Food Service Equipment Brochures" package provided for this project.
- 21. Electrical Contractor (Division26) is to provide power for the Refrigeration Package and all coils. On Walk-in Freezers- The Electrical Contractor (Division 26) to provide electrical service from the Control Panel at the Refrigeration Package to the Evaporator for fan operation and defrost operation.

			ELECTRIC	CAL LEGEND						
SY	MBOLS	CODE	DEFINITION	EXPLANATION						
П	•	ESC	120V ELEC. SUPPLY CONDUIT	CONDUIT STUB OUT OF FLOOR TO BE BRANCHED BY ELECTRICIAN TO J-BOX,						
		ESC	HIGH VOLT. ELECT. SUPPLY CONDUIT	TERMINAL BOX, OR RECEPTACLE.						
$ \Gamma $	•	ESC	120V ELEC. SUPPLY CONDUIT	CONDUIT IN WALL TO TERMINATE IN J-BOX TO BE BRANCHED BY ELECTRICIAN TO						
	(9)	ESC	HIGH VOLT. ELECT. SUPPLY CONDUIT	J-BOX, TERMINAL BLOCK, OR RECEPTACLE.						
	DCO 120V DUPLEX CONVENIENCE OUTLET SCO 120V SINGLE CONVENIENCE OUTLET		CONVENIENCE OUTLET							
				RUN CONDUIT IN WALL AND PROVIDE RECEPTACLE ON WALL AT HEIGHT INDICATED.						
Ŀ	⊕	HVO	HIGH VOLTAGE ELECT. OUTLET							
	DCO 120V DUPLEX CONVENIENCE OUTLET		120V DUPLEX CONVENIENCE OUTLET	ELECTRICIAN SHALL MAKE CONNECTION						
	ф	sco	120V SINGLE CONVENIENCE OUTLET	AND PROVIDE ALL WIRING TO RECEPTACLES MOUNTED ON FIXTURES.						
	Ф	HVO	HIGH VOLTAGE ELECT. OUTLET							
	\$		WALL MOUNTED CONTROL SWITCH	ELECTRICIAN TO PROVIDE CONTROL SWITCHES FOR HOOD LIGHTS AND FAN CONTROLS						
	\$		WALL MOUNTED CONTROL SWITCH	ELECTR. TO MAKE CONNECTION FROM ESC TO SWITCH OR CONTROLS FURNISHED ON EQUIP.						
	Ă		LIGHTS	COLD STORAGE ROOM						
	(A)		ALARM	COLD STORAGE ROOM						
	→		DOOR HEATER	COLD STORAGE ROOM						
		٧	VOLTS							
\vdash	Ø	PH	PHASE							
\vdash		KW	KILOWATTS							
\vdash		AMPS HP	AMPERAGES HORSEPOWER							
\vdash		A.A.F.								
\vdash		D.F.A.	DOWN FROM ABOVE							
_										

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61 1 TYPE 2 HOOD

1 COFFEE BREWER (FUTURE)

1 AIR CURTAIN (W/ PLUNGER)

FEDERAL WAY PERFORMING ARTS & EVENTS CENTER

DFA SEE SHEET FS602 FOR DETAILS.


24 FOR FUTURE USE (PROVIDED BY OWNER)

90 ELEC. CONTRACTOR TO FEILD INSTALL DOOR PLUNGER

Sheet Number

GEL

Electrical Requirement

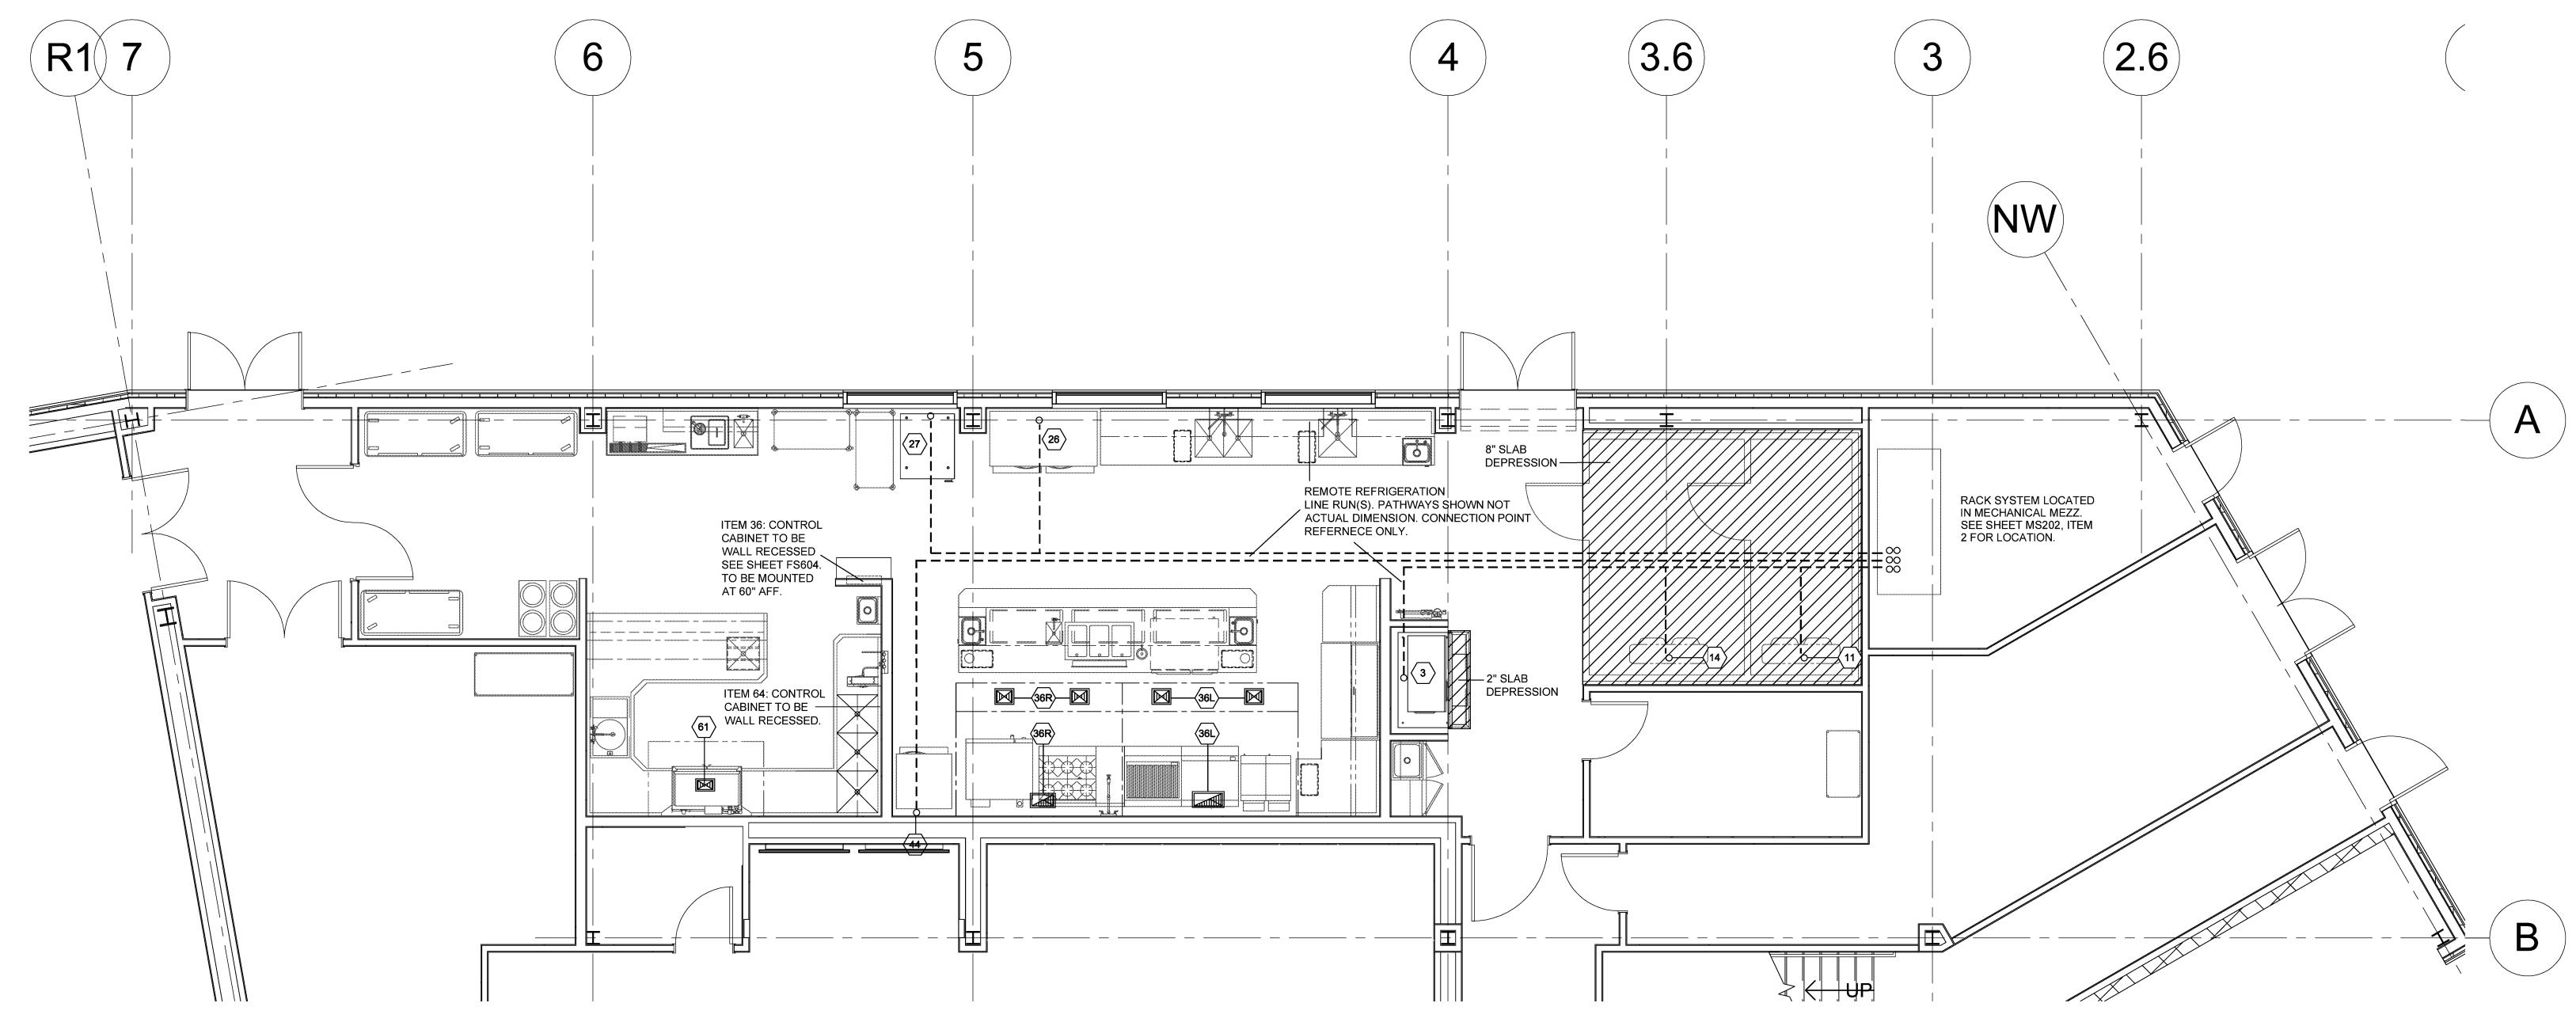

KITCHEN & SERVERY - SPECIAL CONDITION REQUIREMENT PLAN SCALE: 1/4" = 1'-0"

SPECIAL CONDITION REQUIREMENT NOTES

A. GENERAL NOTES:

- 1. All work indicated on the drawing must be completed by other than the kitchen equipment contractor and must comply with all local codes and restrictions.
- This building conditions plan is intended to show special building and ventilation requirements for the food service equipment only. Any additional building conditions or ventilation requirements refer to architectural / engineering plans.
- 3. Walls, floors, and ceilings in food service areas where food and beverage is prepared shall be smooth, easily cleanable, non-absorbent, and durable. Wall and ceiling shall be light in color.
- 4. Refer to the approved shop drawings for supplemental coordination and installation requirements for the food service equipment indicated on this plan.
- Requirements indicated on this plan for existing and owner or purveyor provided equipment are minimum guidlines only and specifications must be verified with equipment provided. 6. Prior to the installation of the food service equipment the kitchen equipment contractor must confirm that:
 - a. The ceilings are installed and finished.b. The walls are installed and finished.
 - c. The flooring has been installed and washed clean.
 d. A loading dock is available and to coordinate with G.C any window, door or passages required for the delivery of food service equipment.
- 7. The mounted height for the bottom edge of the hoods to be 6'-6" to 7'-0" above finished floor or per local code requirements.
- 8. Final duct connections to equipment by Mechanical Division.

B. GENERAL CONTRACTOR REQUIREMENTS:

- Refer to Architectural / Engineering drawings and specifications for the following General Contractor requirements.
- 1. The in-wall reinforcing or wall backing for all wall mounted semi-recessed equipment or control panels.
- 2. All walls mounted behind, above and adjacent to cooking equipment shall be constructed of limited-combustible material with 2-hour or greater fire rating.
- 3. A 6" deep depression for all walk-in cooler / freezers with a smooth and transit level finis. The finished floor material and coved bases are to be installed after the walk-in insulation have been set in place.
- 4. A 8" high concrete pad with trowel smooth and level finished where indicated.
- 5. Any fire rated materials for exhaust vent ducts, vent stacks, and any heat producing food service equipment. Verify compliance with local codes and regulations.
- The cove bases at all vertical intersections of all kitchen floors.
- All conduits for refrigeration or beverage lines shall have a smooth interior finish, a minimum radius of 24" at all bends and a minimum 16" x 18" x 12" deep accessible pull box on all conduit runs in excess of 95'-0," in all floors or concealed spaces. The total of all bends between pull boxes not to exceed 180°. Stub conduit ends out 2" from walls or 2" above finished floors. Verify compliance with local codes and
- Provide all penetration and sleeves through walls, floors and and ceilings as required for all utility lines, refrigeration lines, beverage lines and ventilation ducts. All penetrations must be coordinated with kitchen equipment contractor and shall be sealed by G.C. in accordance with local fire and building codes.
- 9. All pads or curbs for food service equipment and /or roof or service area mounted compressor rack. Verify compliance with local codeds and regulations.
- 10. All openings in walls as indicated on this plan for and recessed or semi-recessed control panels.
- 11. Slope all floors to floor sinks, floor drains or floor troughs. verify with local codes.
- 12. A 6" recess for floor trough at cooking lines, and 2" recess for troughs at ice machines. Trough provided by kitchen equipment contractor, installed by general contractor.
- 13. A minimum of 150 lbs. per square foot floor loading, or higher as required by local codes.
- 14. Recommended finished ceiling heights in kitchen areas and for specific food service equipment areas:
 a. Kitchen area 10'-0"

Adequate space is needed above the finished ceilings for exhaust hood ducts and mechanical / electrical work. Please notify JLR Design Group if heights are less than recommended minimums.


VENTILATION SCHEDULE

TEM NO.	EXHAUST CONNECTION SIZE	QTY.	EXHAUST CFM	SP AT COLLAR	SUPPLY CONNECTION SIZE	QTY.	SUPPLY CFM	SP AT COLLAR	REMARKS / REQUIREMENTS
36L	20" X 10"	1	2126	1.50	12" X 10"	2	583	0.40	SEE VENTILATOR DWG.
36R	15" X 9"	1	1410	1.25	12" X 10"	2	583	0.40	SEE VENTILATOR DWG.
61	8" X 10"	1	1080	0.50					SEE VENTILATOR DWG.

COMPLIANCE WITH 2012 WASHINGTON STATE ENERGY CODE, SECTIONS C402.5, C402.6, & C403.5

K-FACTOR - ,1378 FOR COOLERS / ,1232 FOR FREEZERS U-FACTOR - 7.257 FOR COOLERS / 8.117 FOR FREEZERS 4" PANEL R-FACTOR - 29.03 FOR COOLERS / 32.47 FOR FREEZERS
5" PANEL R-FACTOR - 36.29 FOR COOLERS (WALLS AND ROOFS) / 40.59 FOR FREEZERS (WALLS AND ROOFS) FREEZER FLOOR INSULATION R-FACTOR - 32.47 / INSULATED FREEZER SLAB R-FACTOR - 28.0 HINGED DOORS TO INCLUDE DOOR CLOSER, STRIP CURTAINS, AND A PRE-SET ANTI-SWEAT DOOR FRAME HEATER WIRE TRIPLE-PANE GLASS WINDOWS

SPRING-LOADED HINGES, 42" WIDE DOORS & BELOW / SPRING ACTION HEAVY DUTY DOOR CLOSER, DOORS WIDER THAN 42"

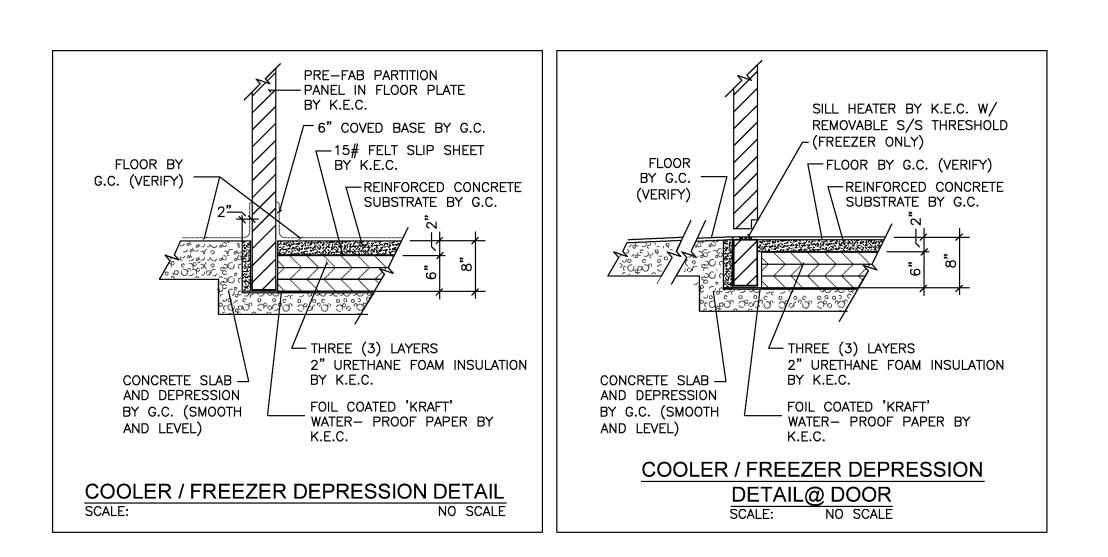

SPECIAL CONDITIONS **SYMBOLS**

	EXHAUST DUCT
	REPLACEMENT AIR DUCT
CFM	CUBIC FEET PER MINUTE
	FLOOR DEPRESSION
	SOLID MASONARY PAD
	REFRIGERATION LINES
	IN-WALL BACKING

Sheet Number



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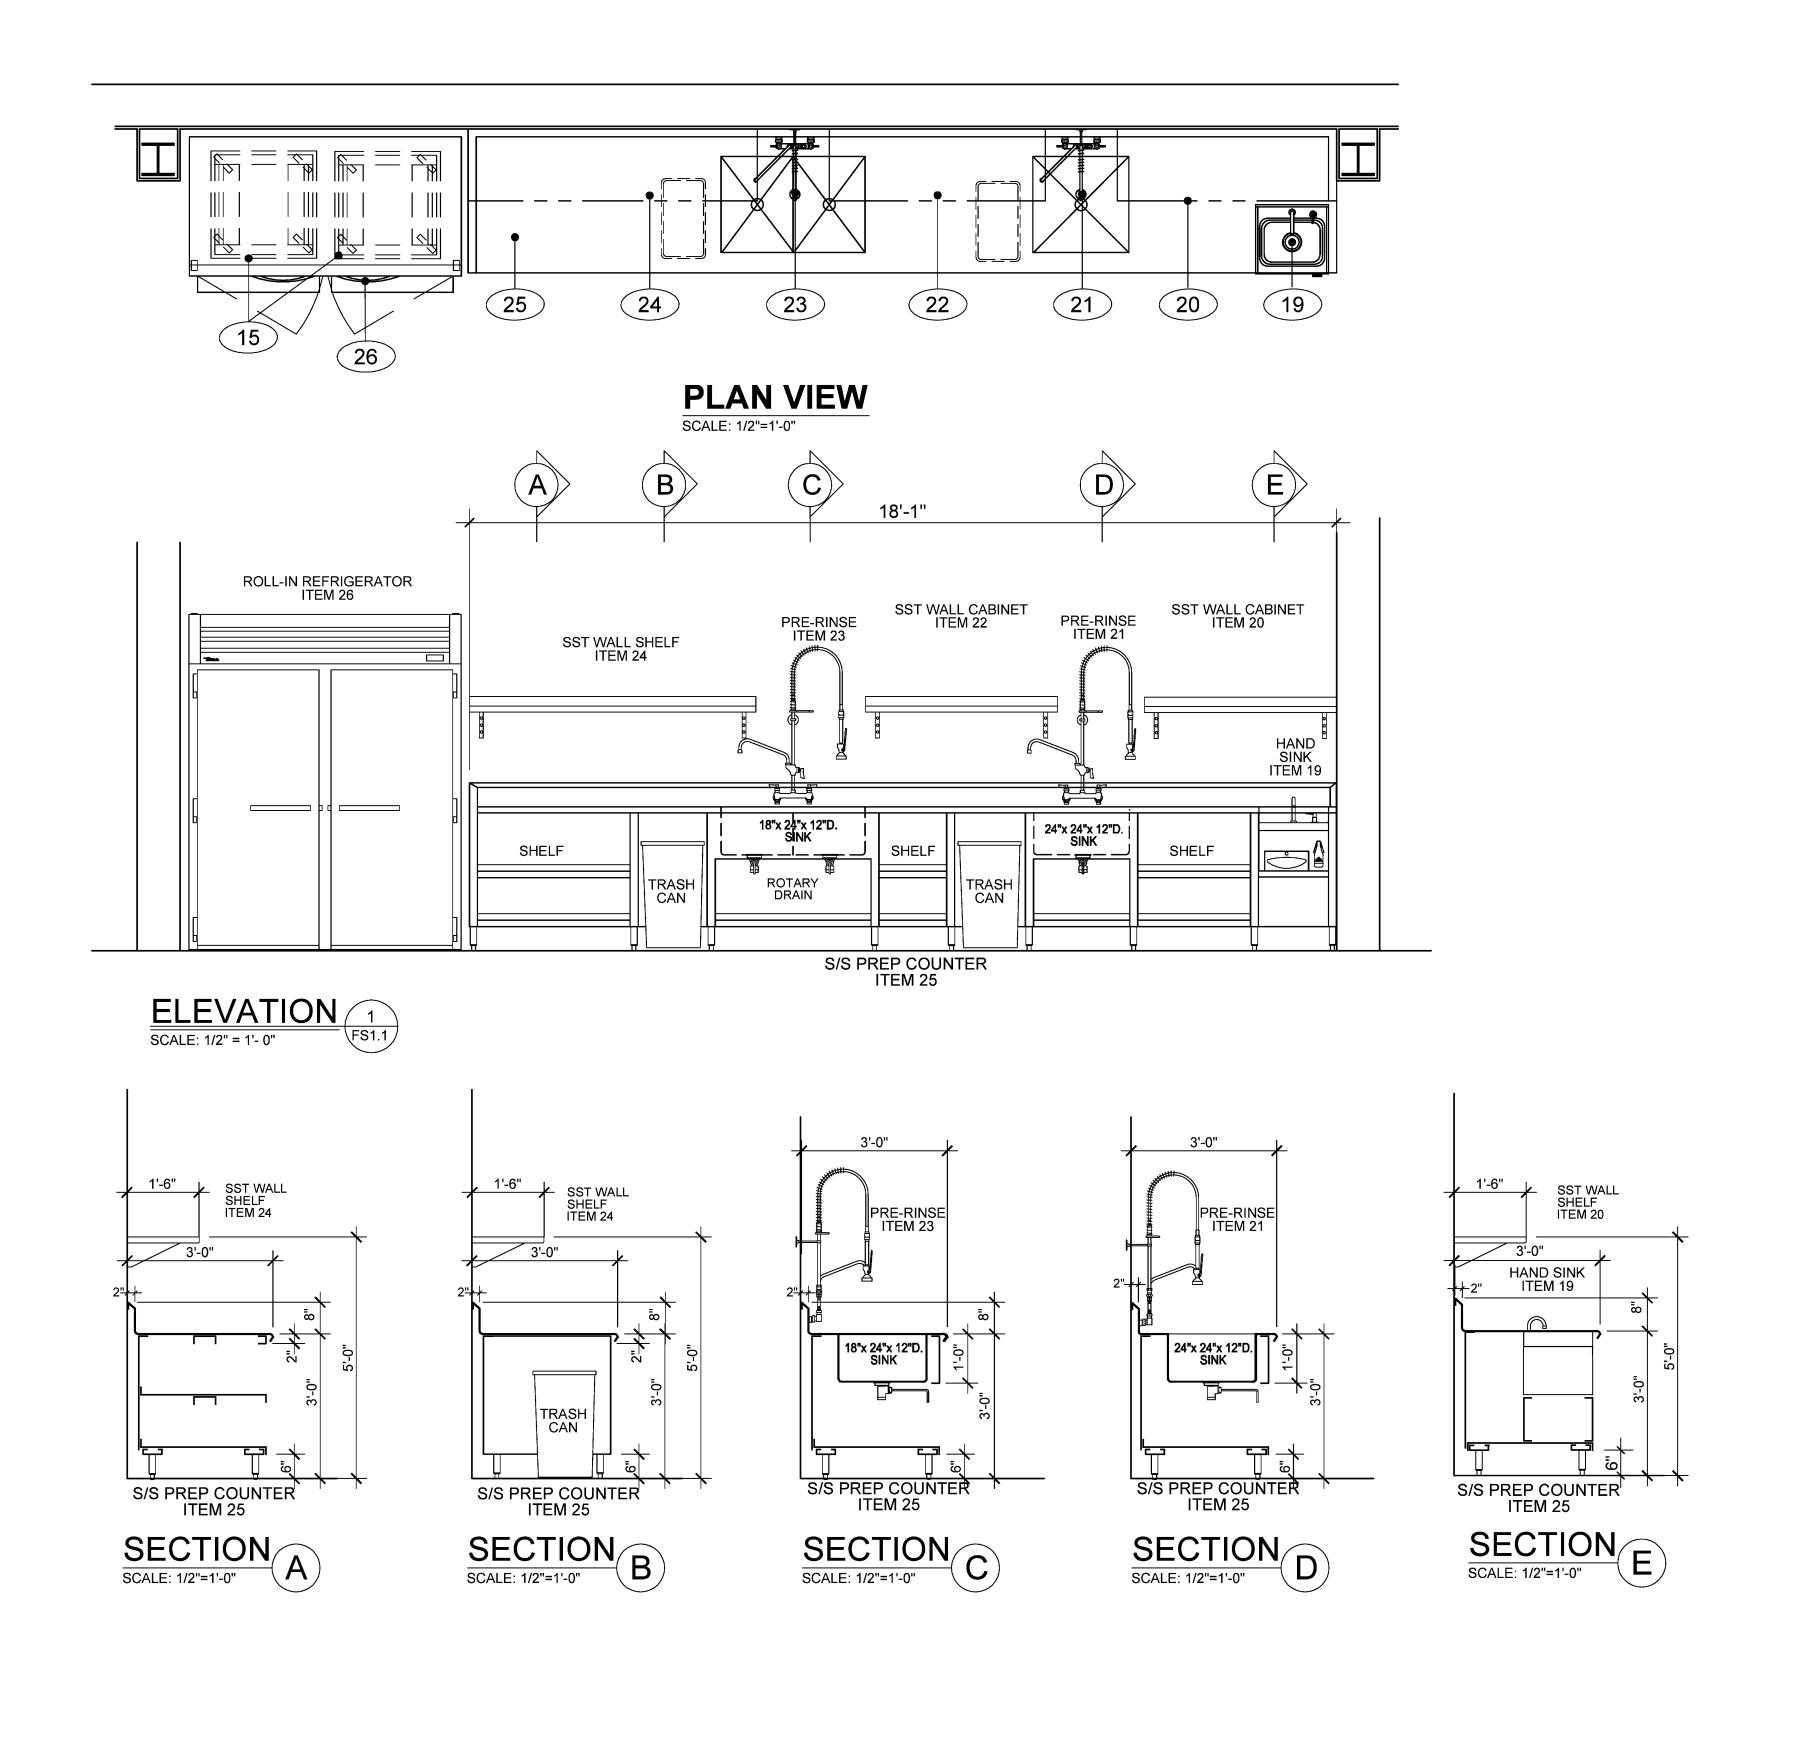
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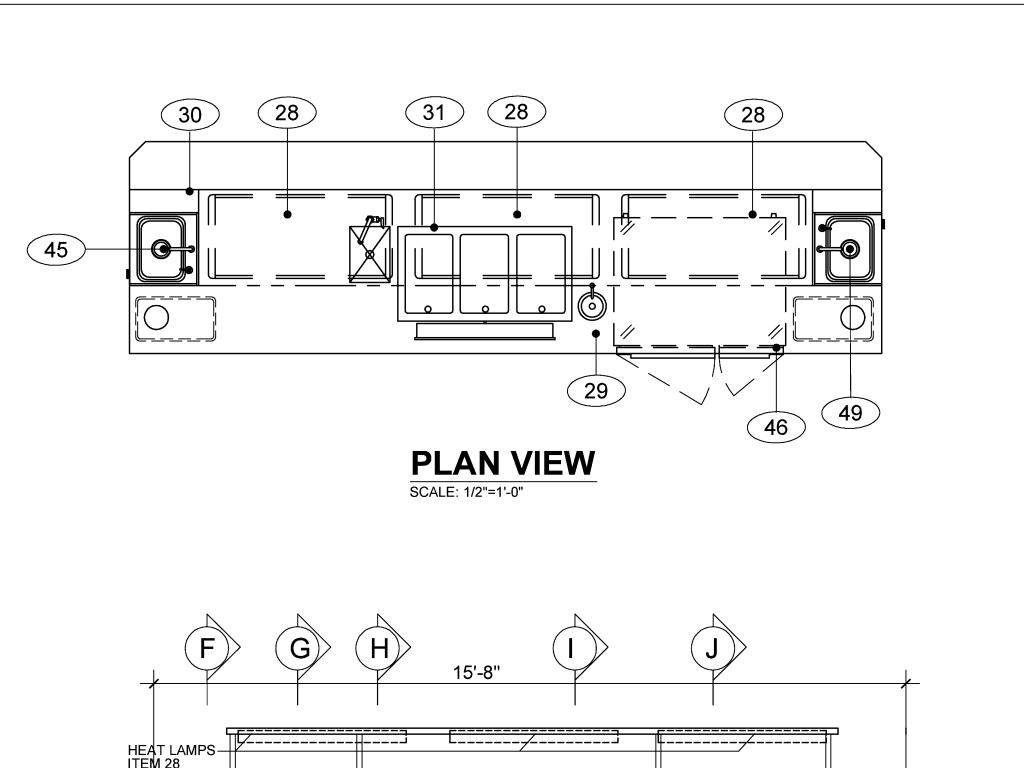
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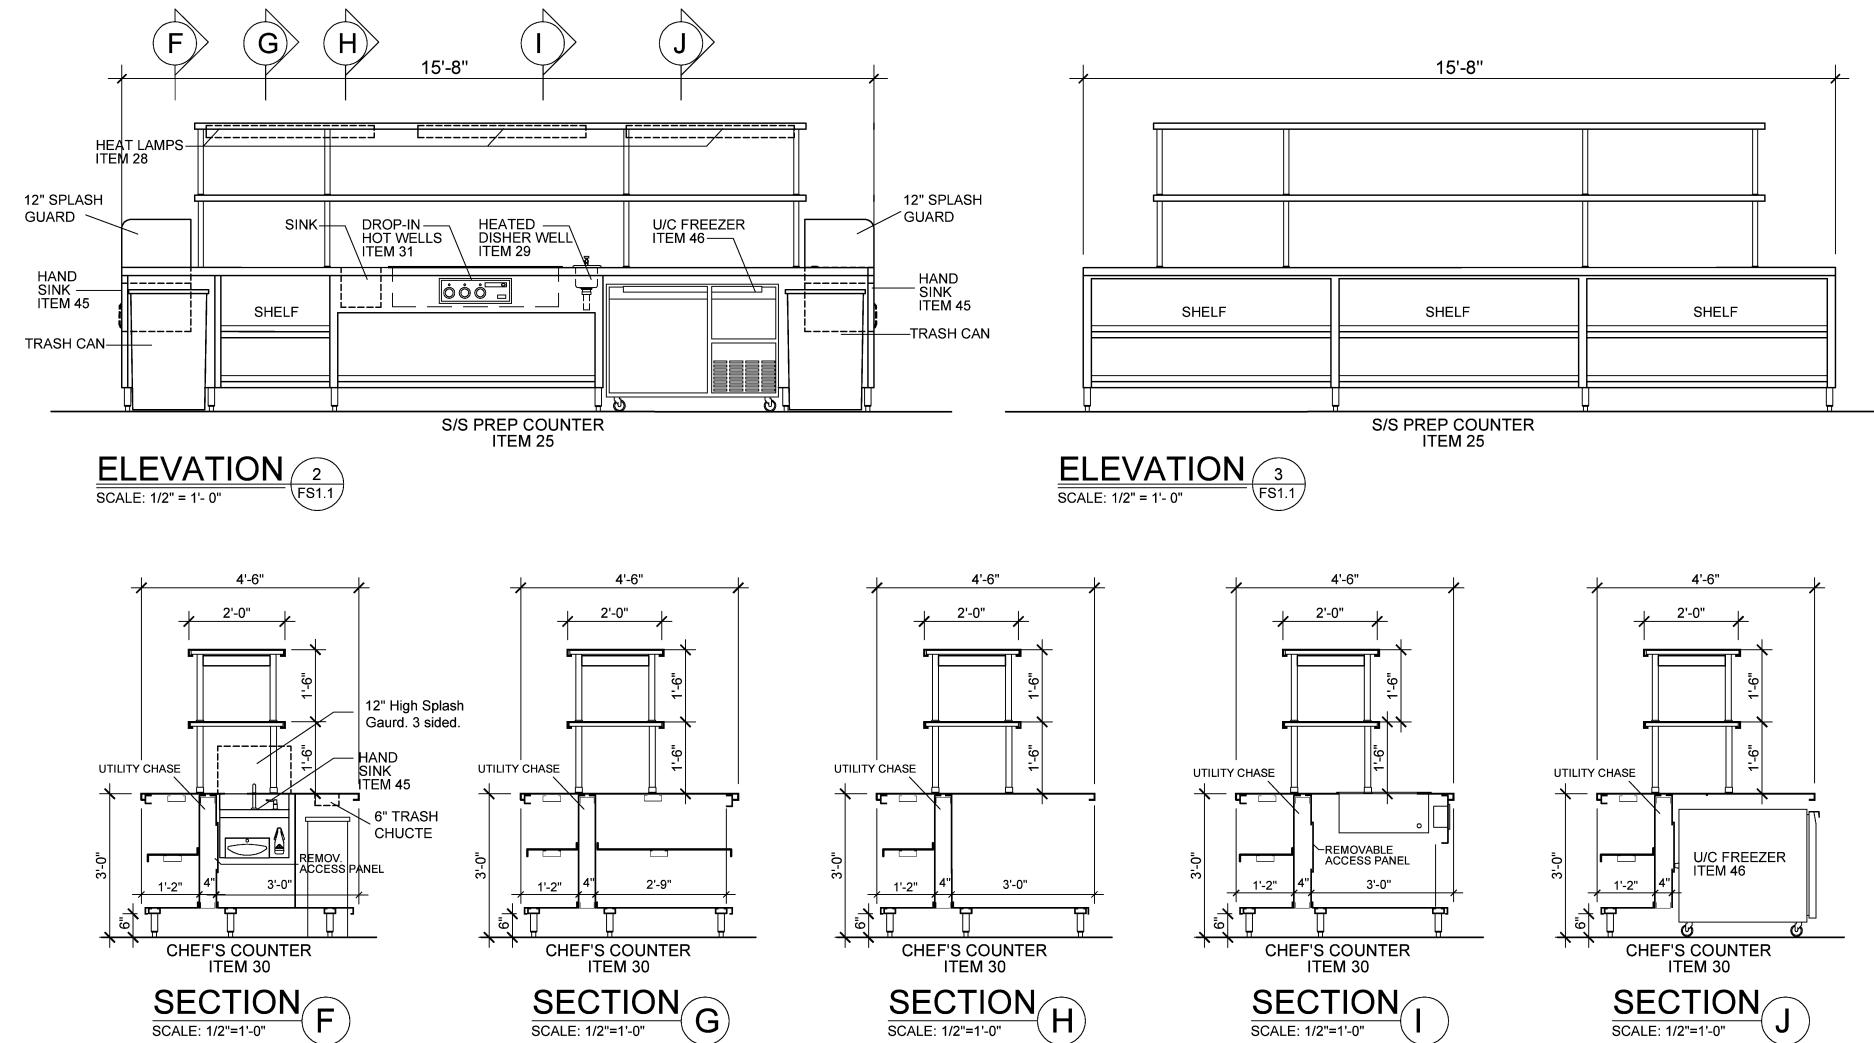
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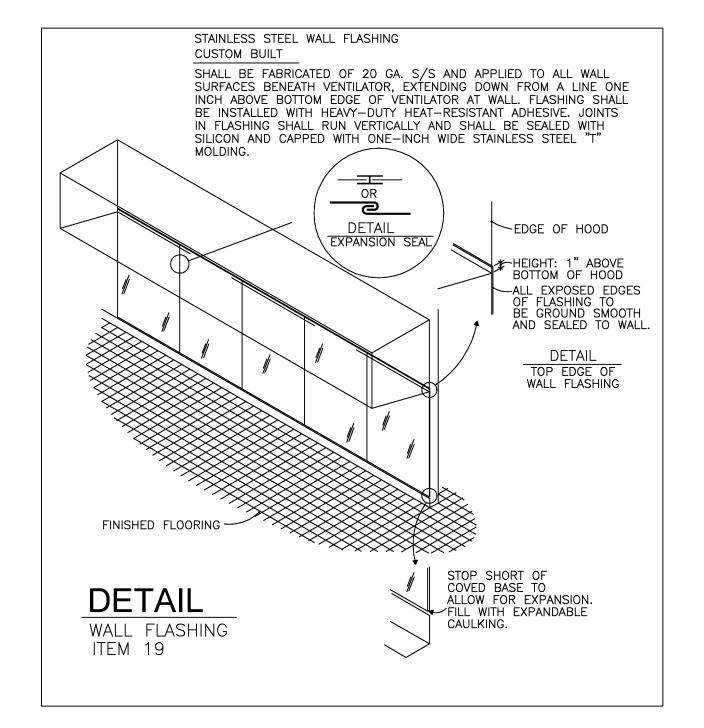



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DETAIL
SCALE: 1/2"=1'-0"

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South and South 316th Street

Sheet Number

CHROME PIPING
BY PLUMBER VACUUM BREAKER
PROVIDED BY

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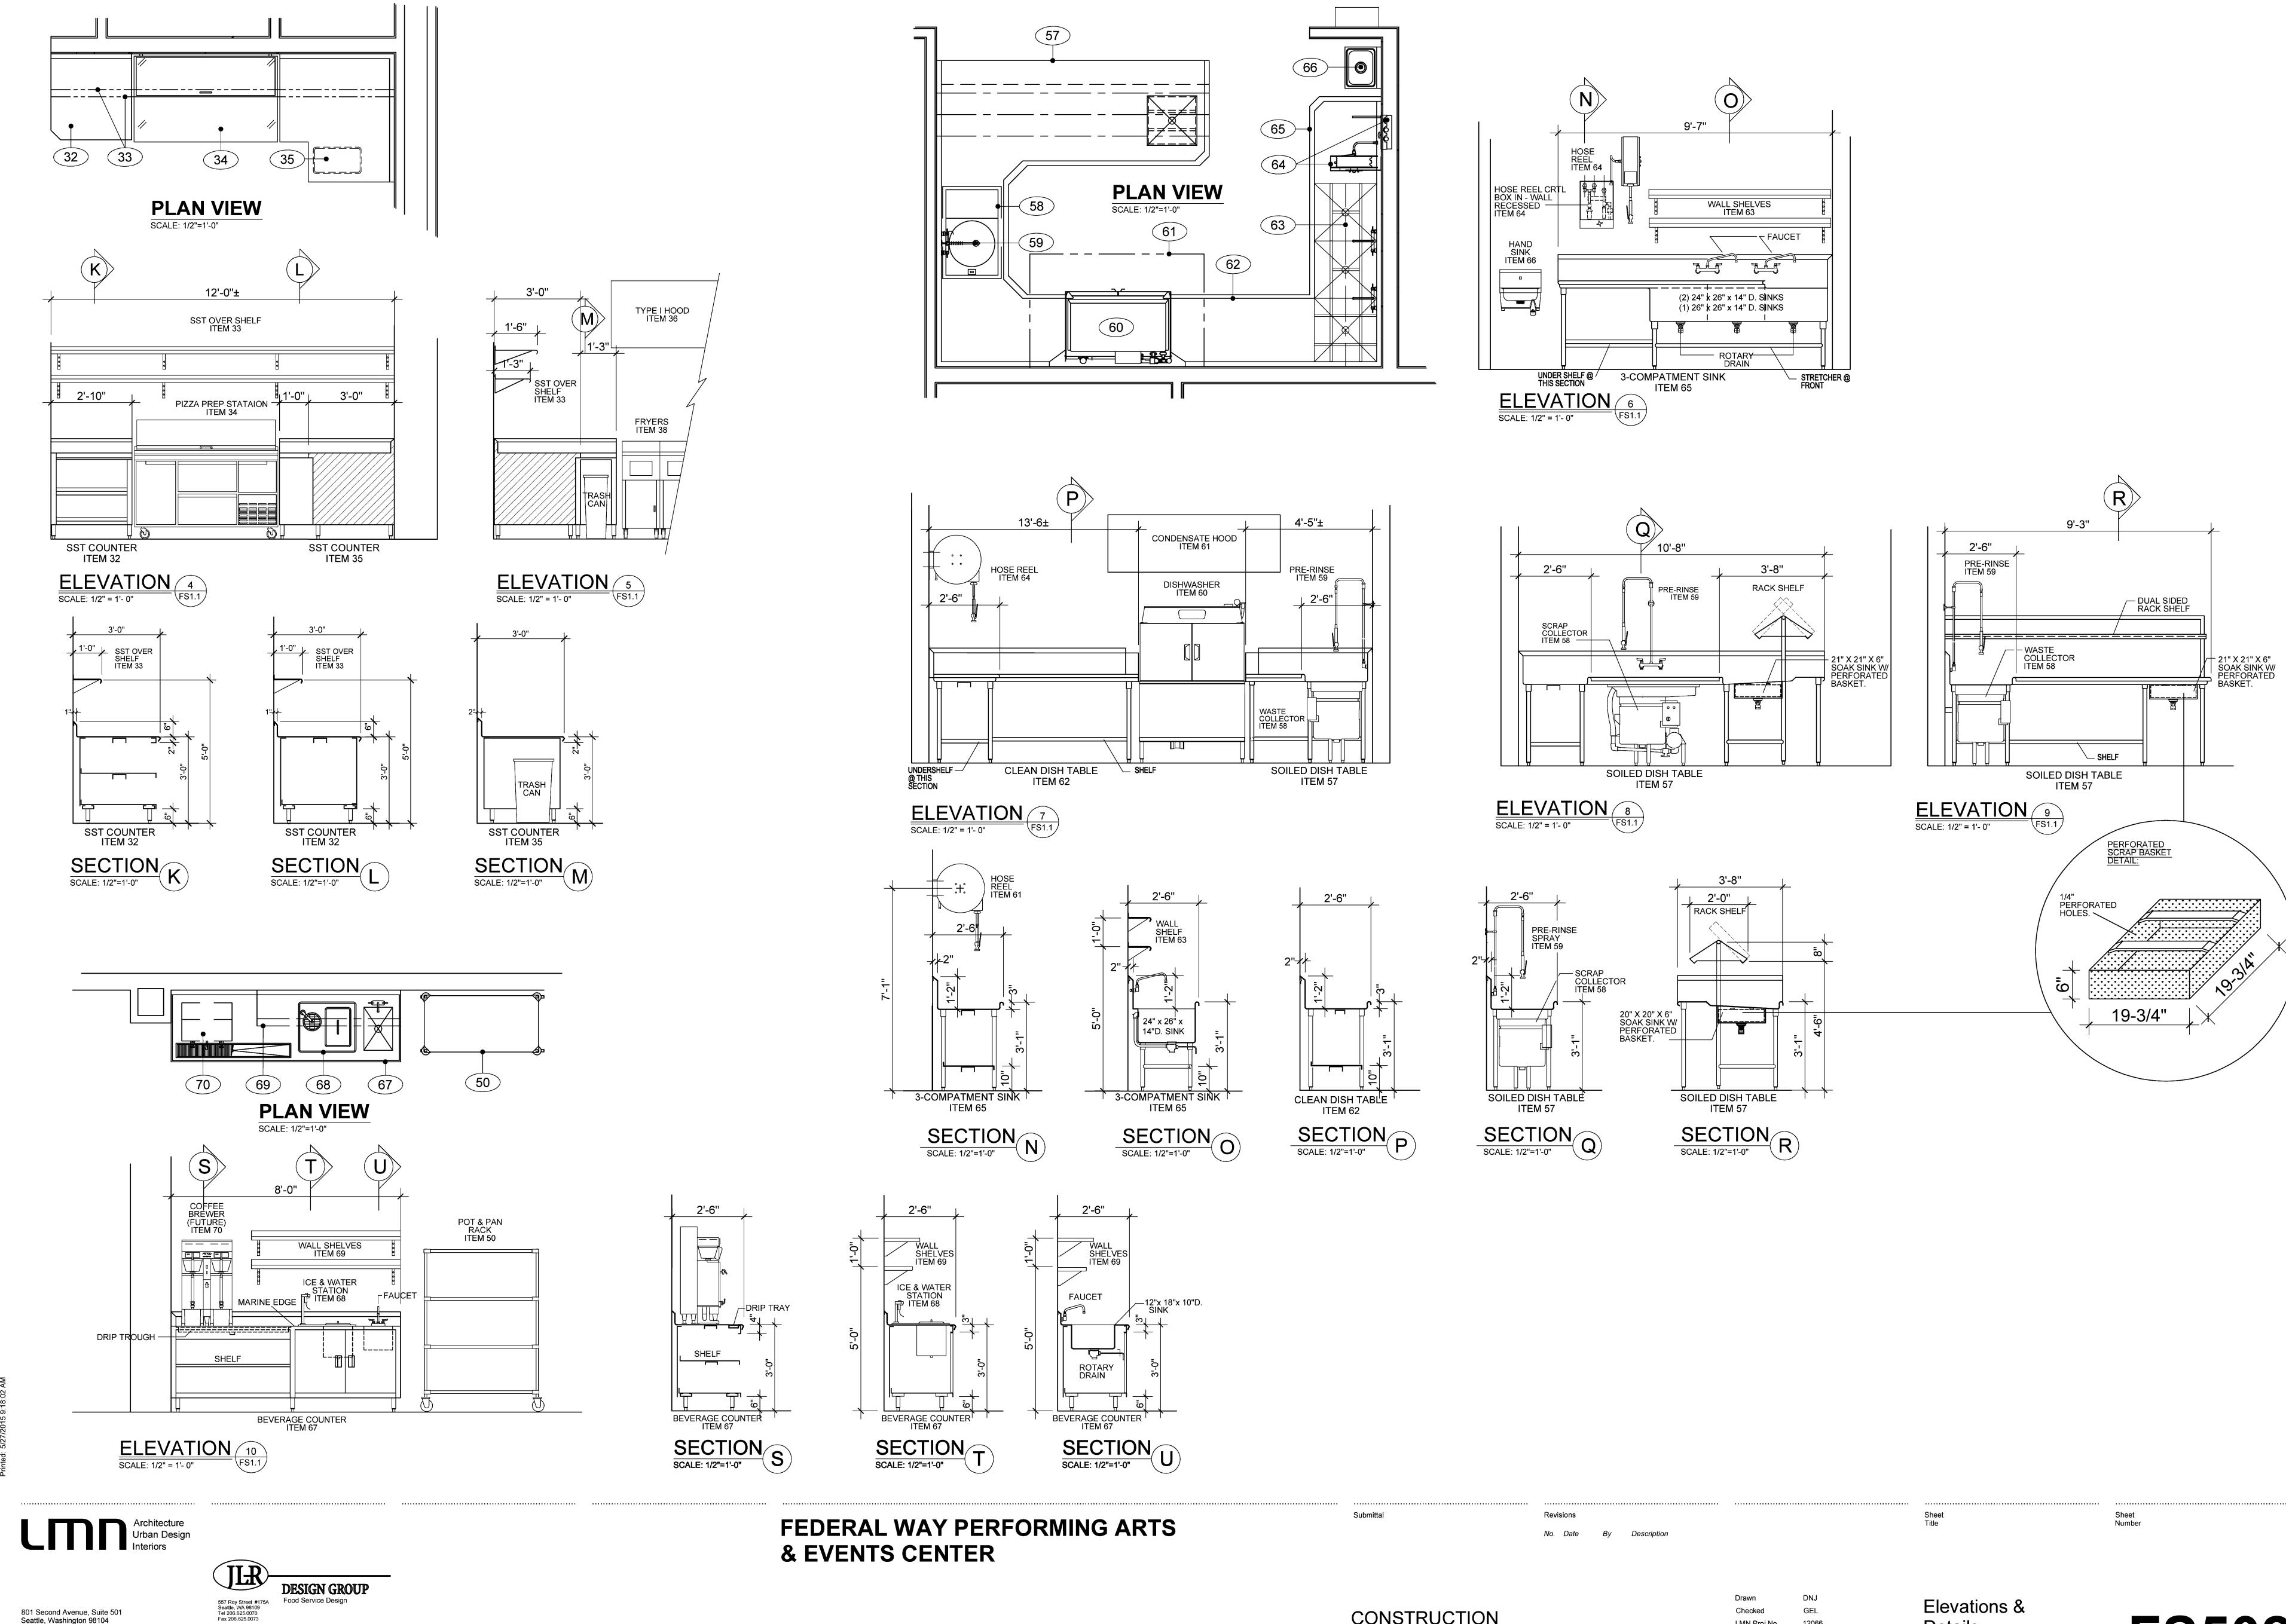
PROVIDED BY K.E.C. INSTALLED

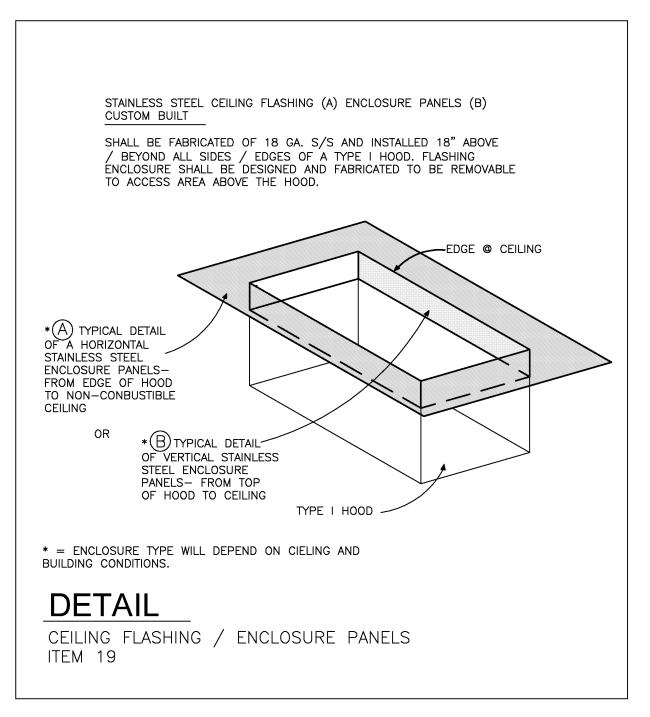LINE IN WALL BY PLUMBER

₩ PLUMBING CON

REEL RINSE CONTROL BOX

PLUMBING CONNECTIONS



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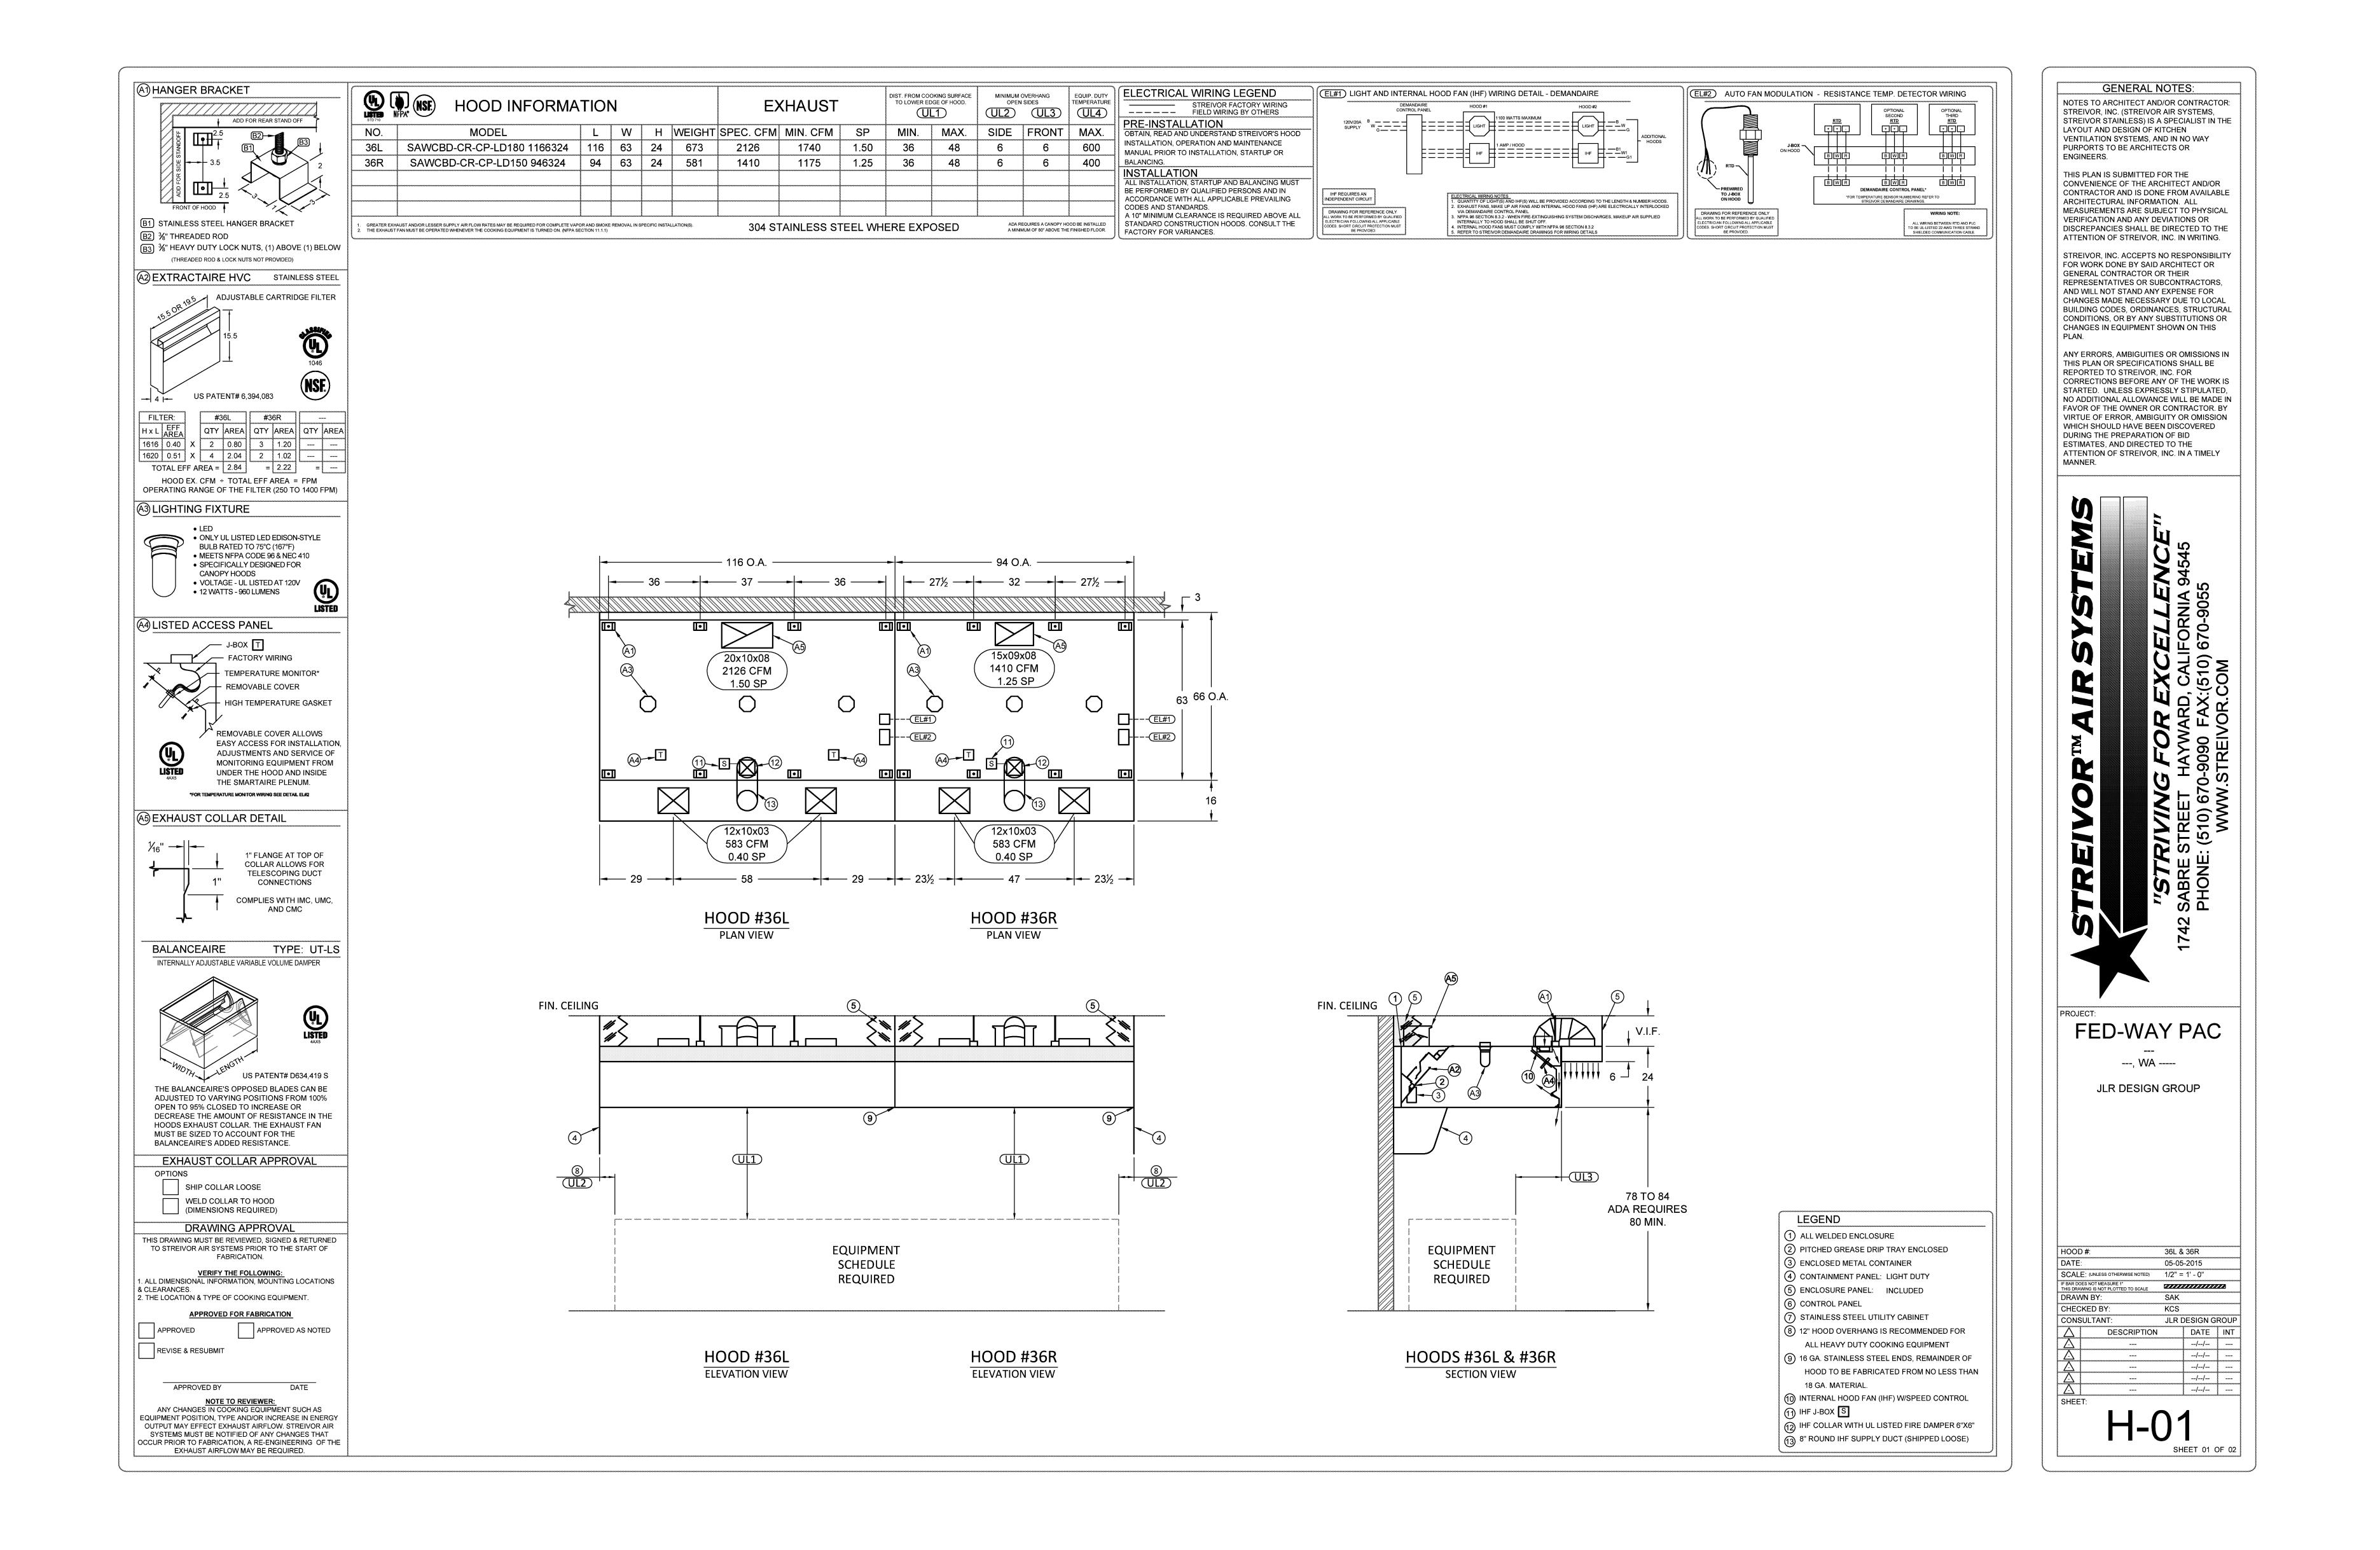
Northeast corner of 20th Avenue South and South 316th Street

CONSTRUCTION DOCUMENTS

Drawn Checked 14 AUGUST 2015

Elevations & Details

FS502




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GENERAL NOTES:

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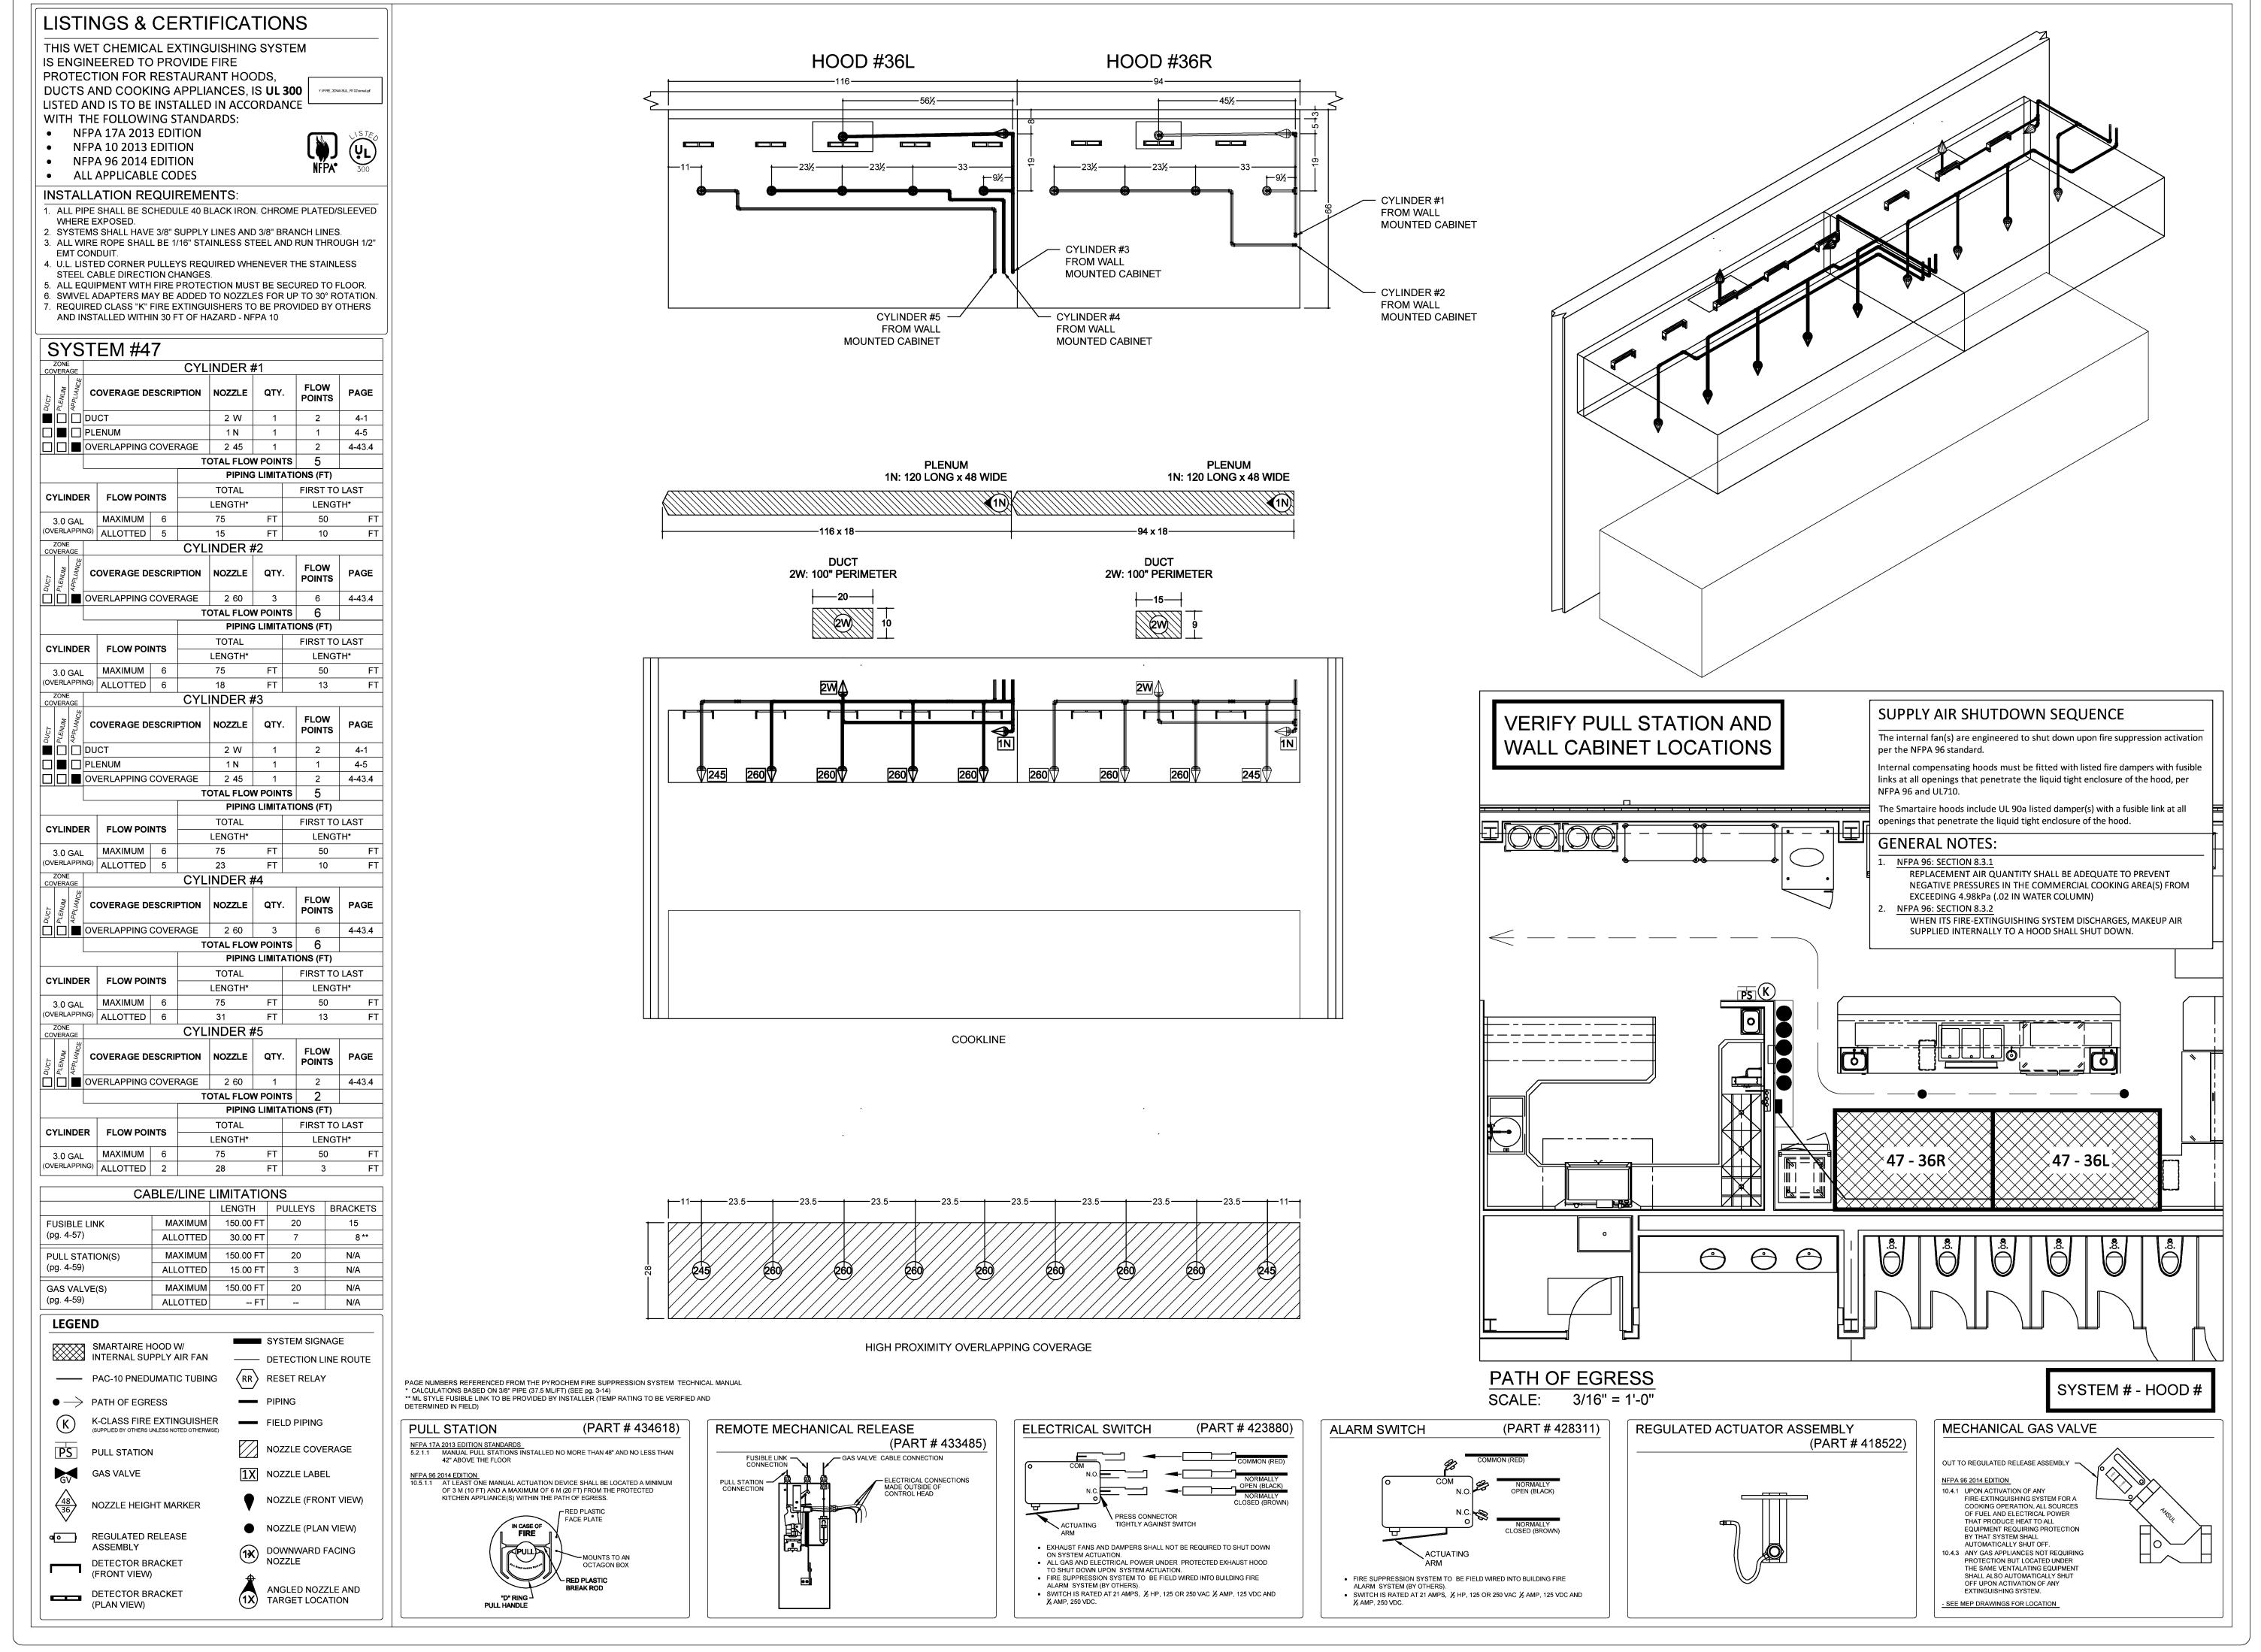
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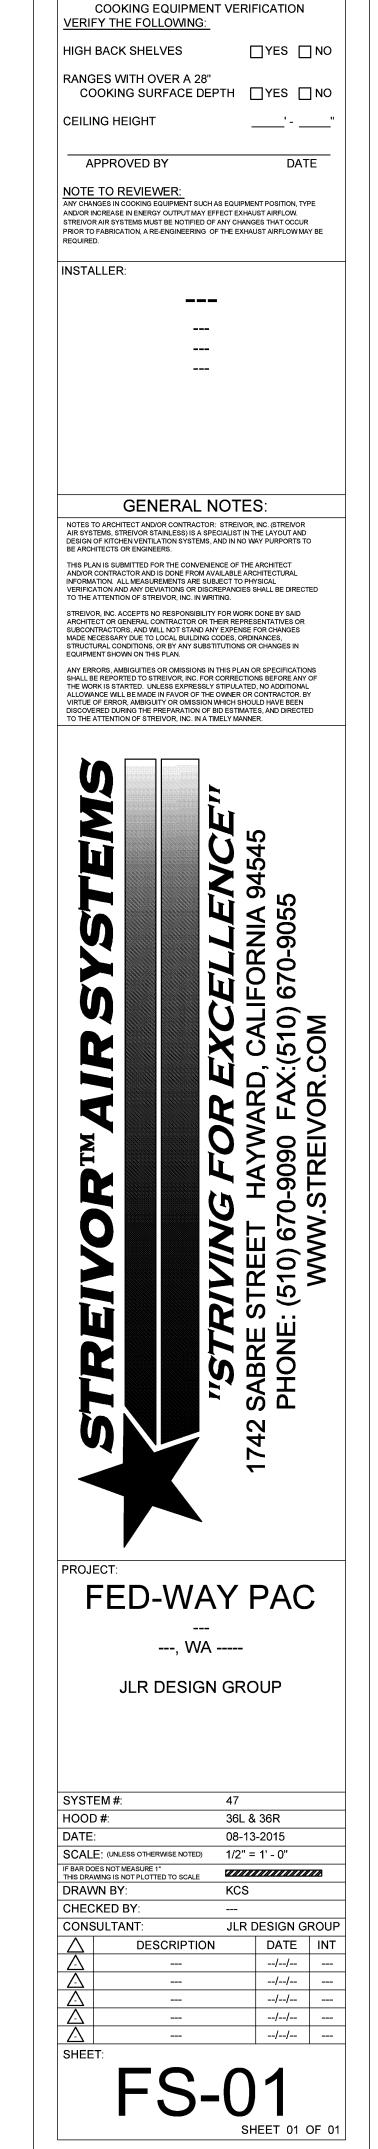
13 JULY 2015

Ventilator Details

Northeast corner of 20th Avenue

PERMIT SET

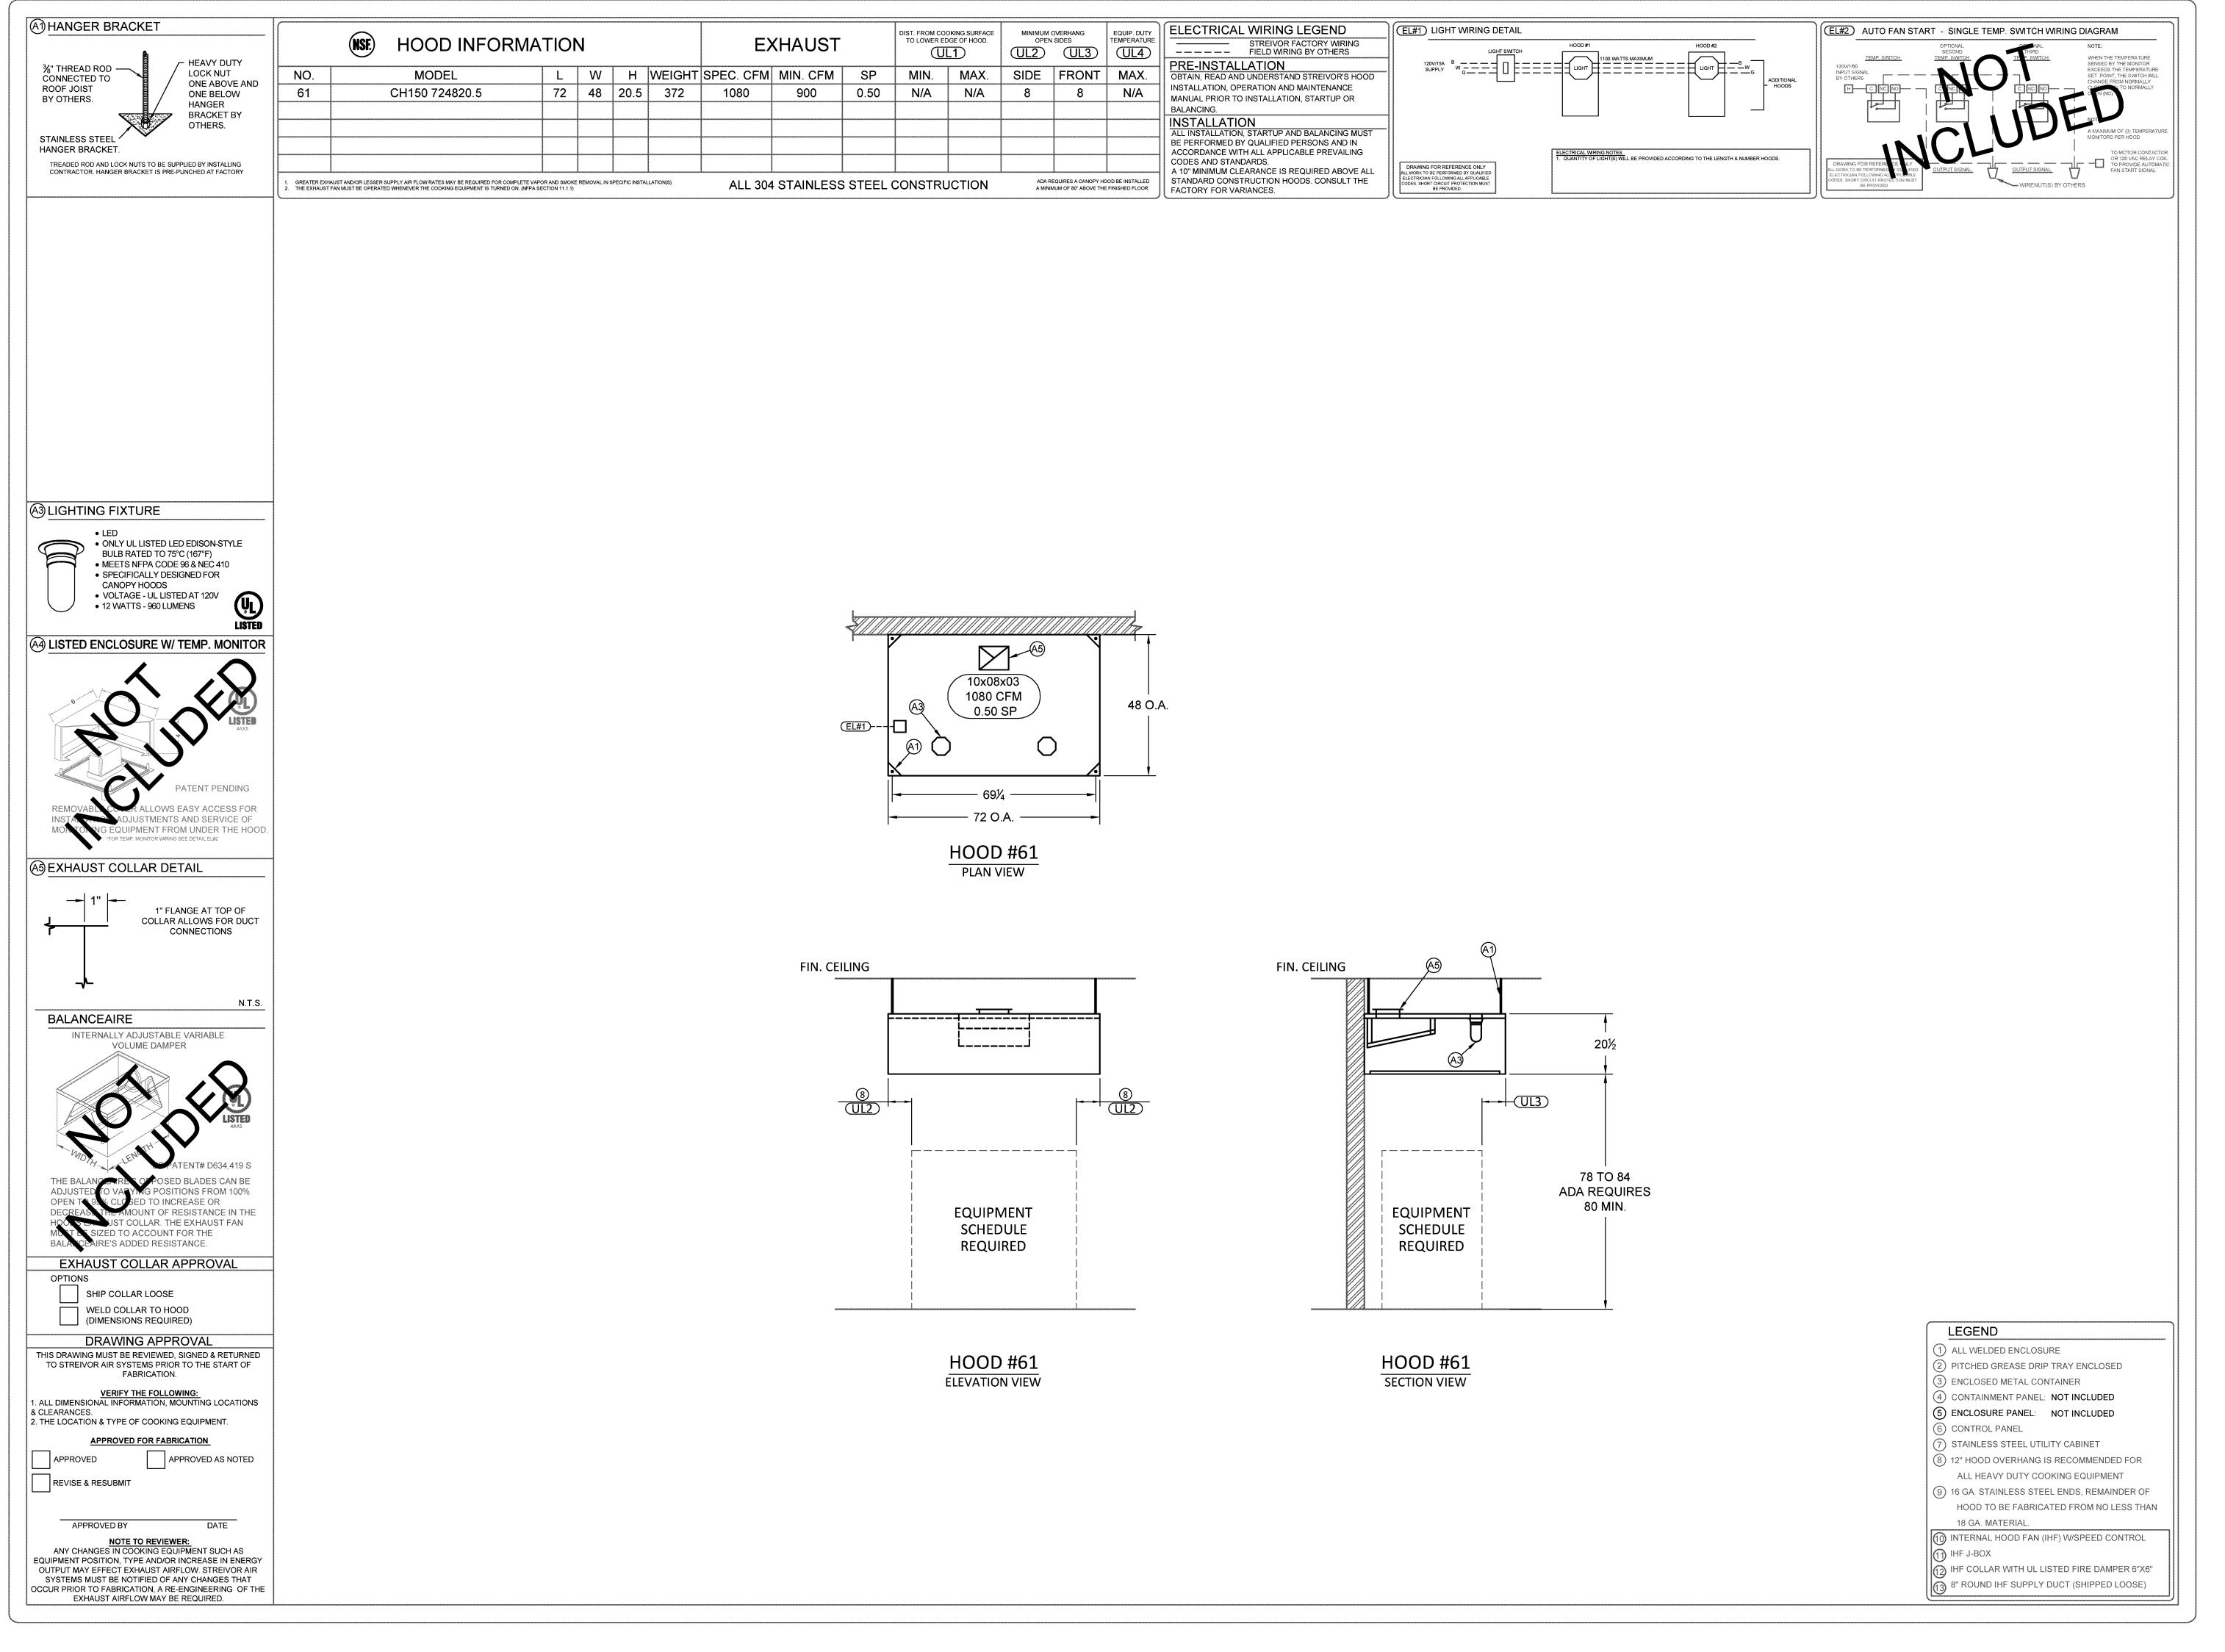



CUSTOMER APPROVAL

Architecture Urban Design Interiors



FEDERAL WAY PERFORMING ARTS & EVENTS CENTER

Northeast corner of 20th Avenue South and South 316th Street

Revisions


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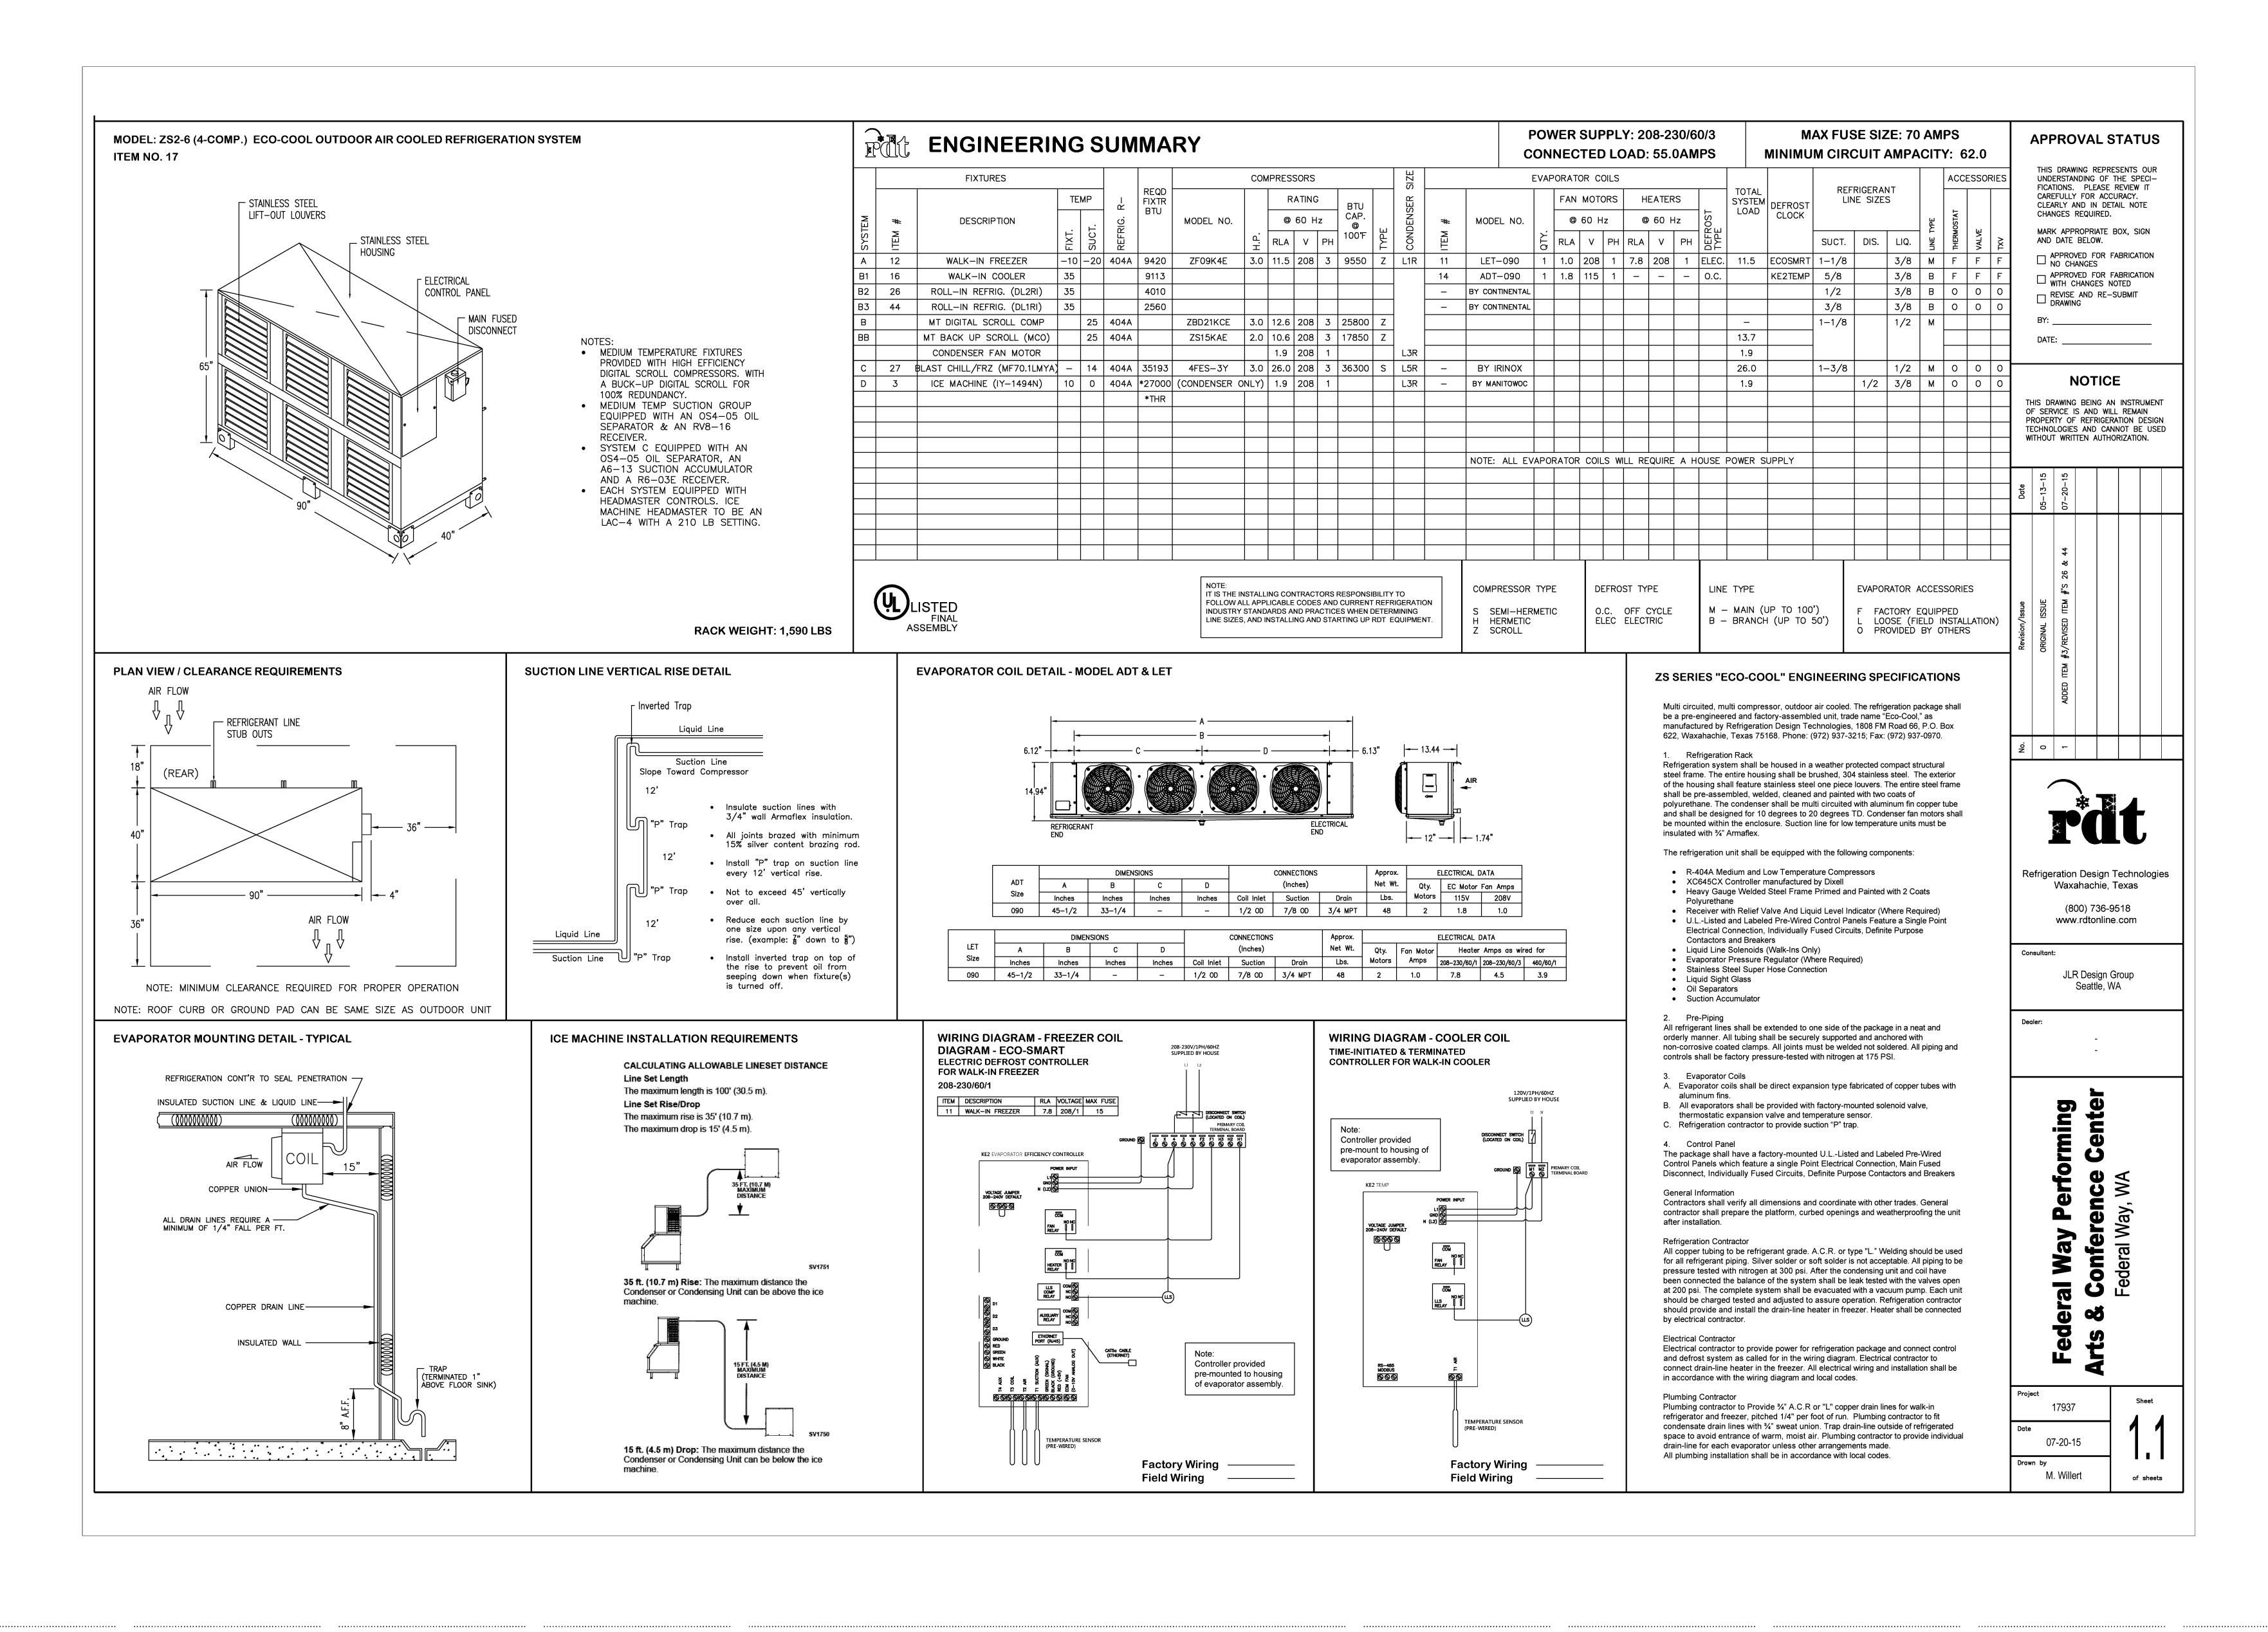
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GEL 14 AUGUST 2015

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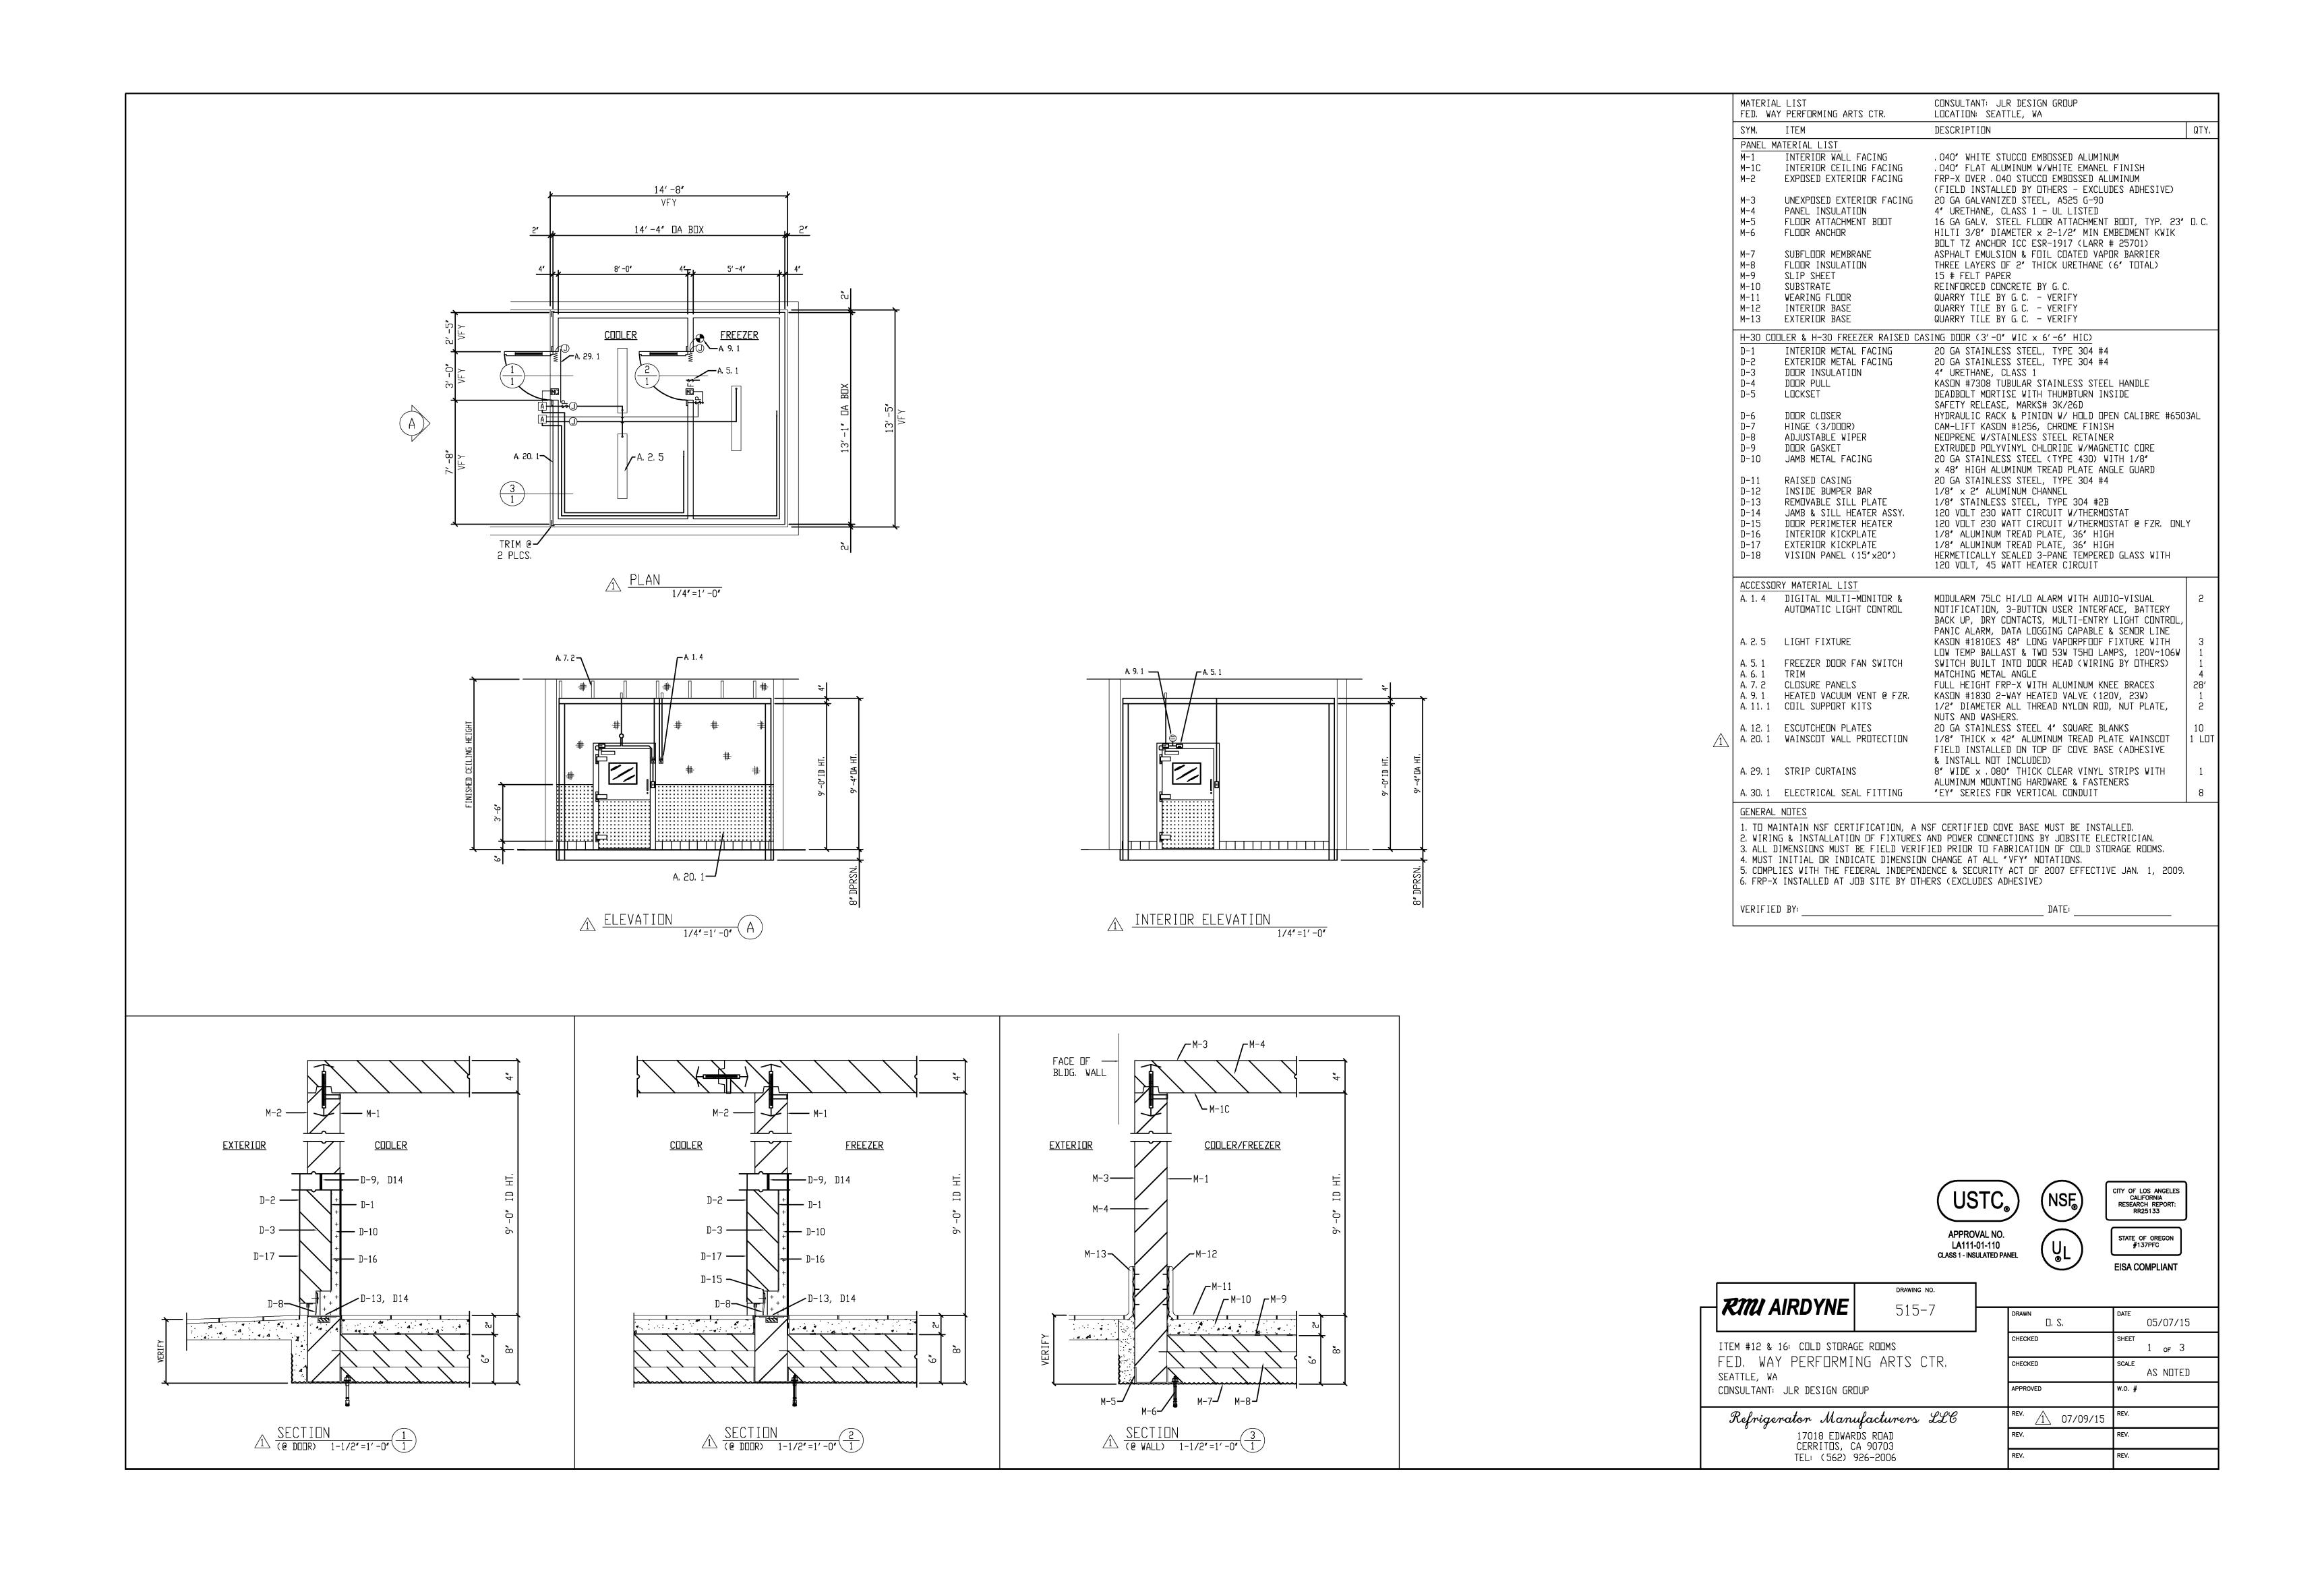
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Refrigeration **Details**

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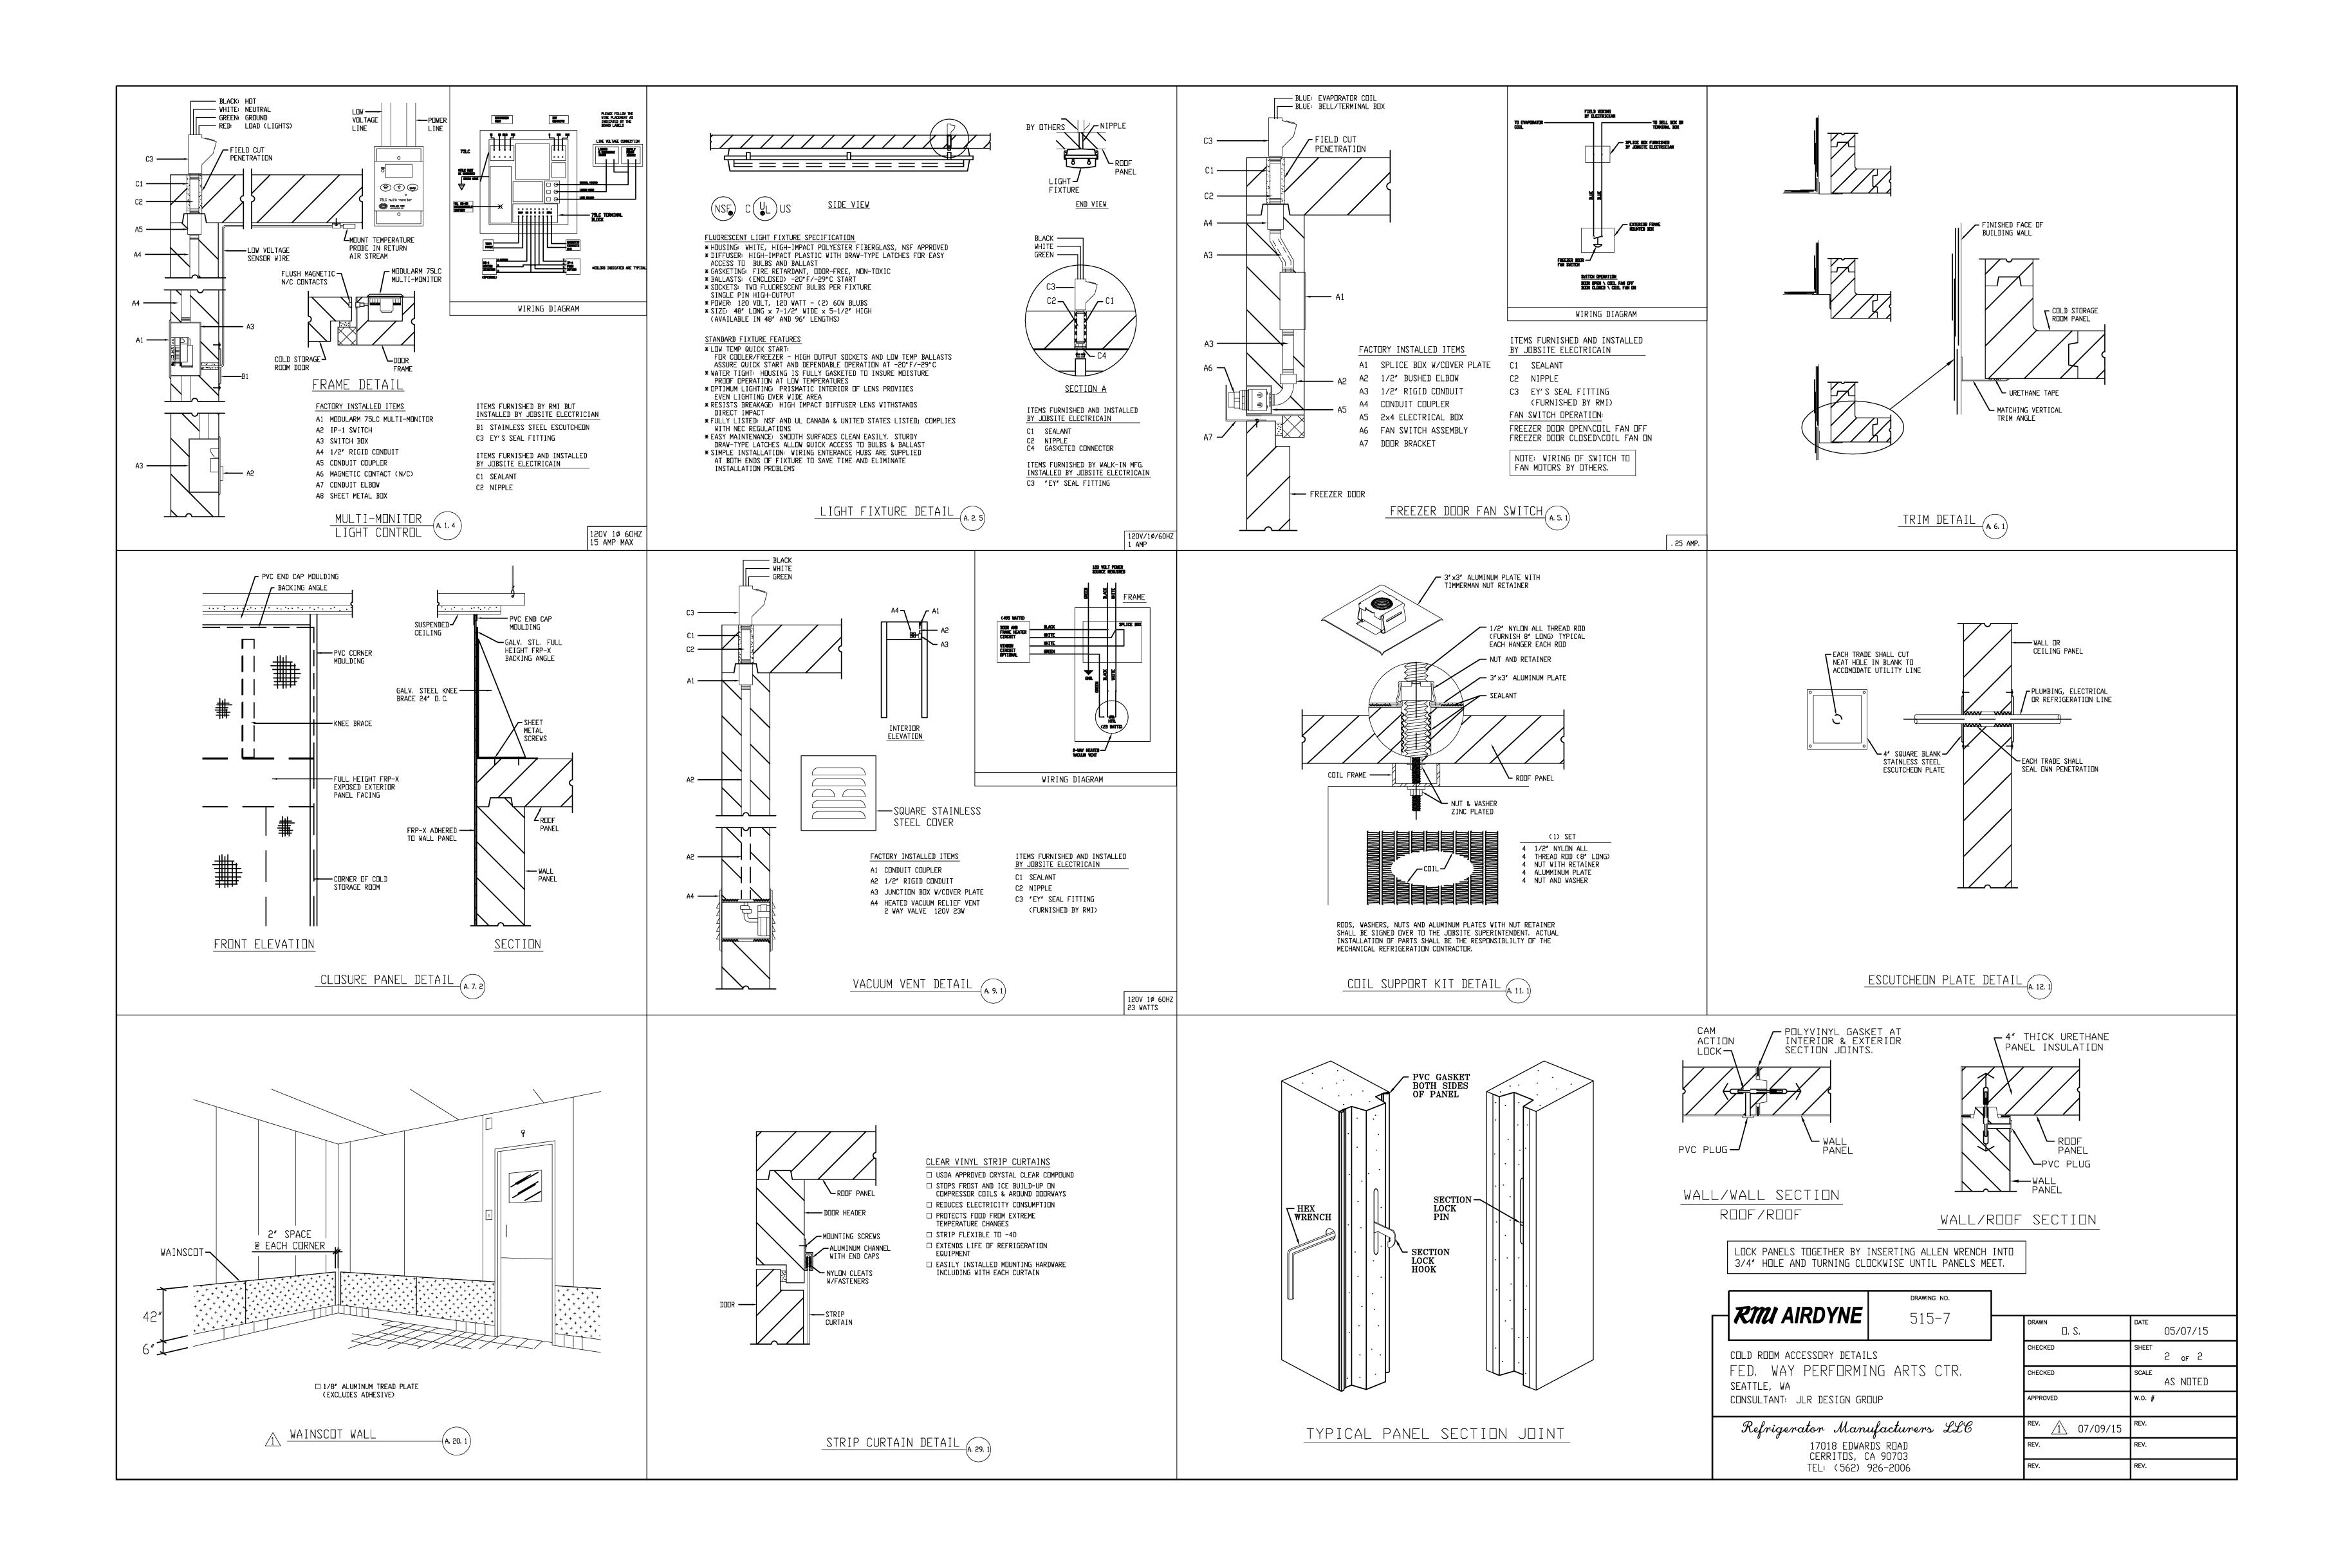
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Walk-in Cooler / Freezer Details



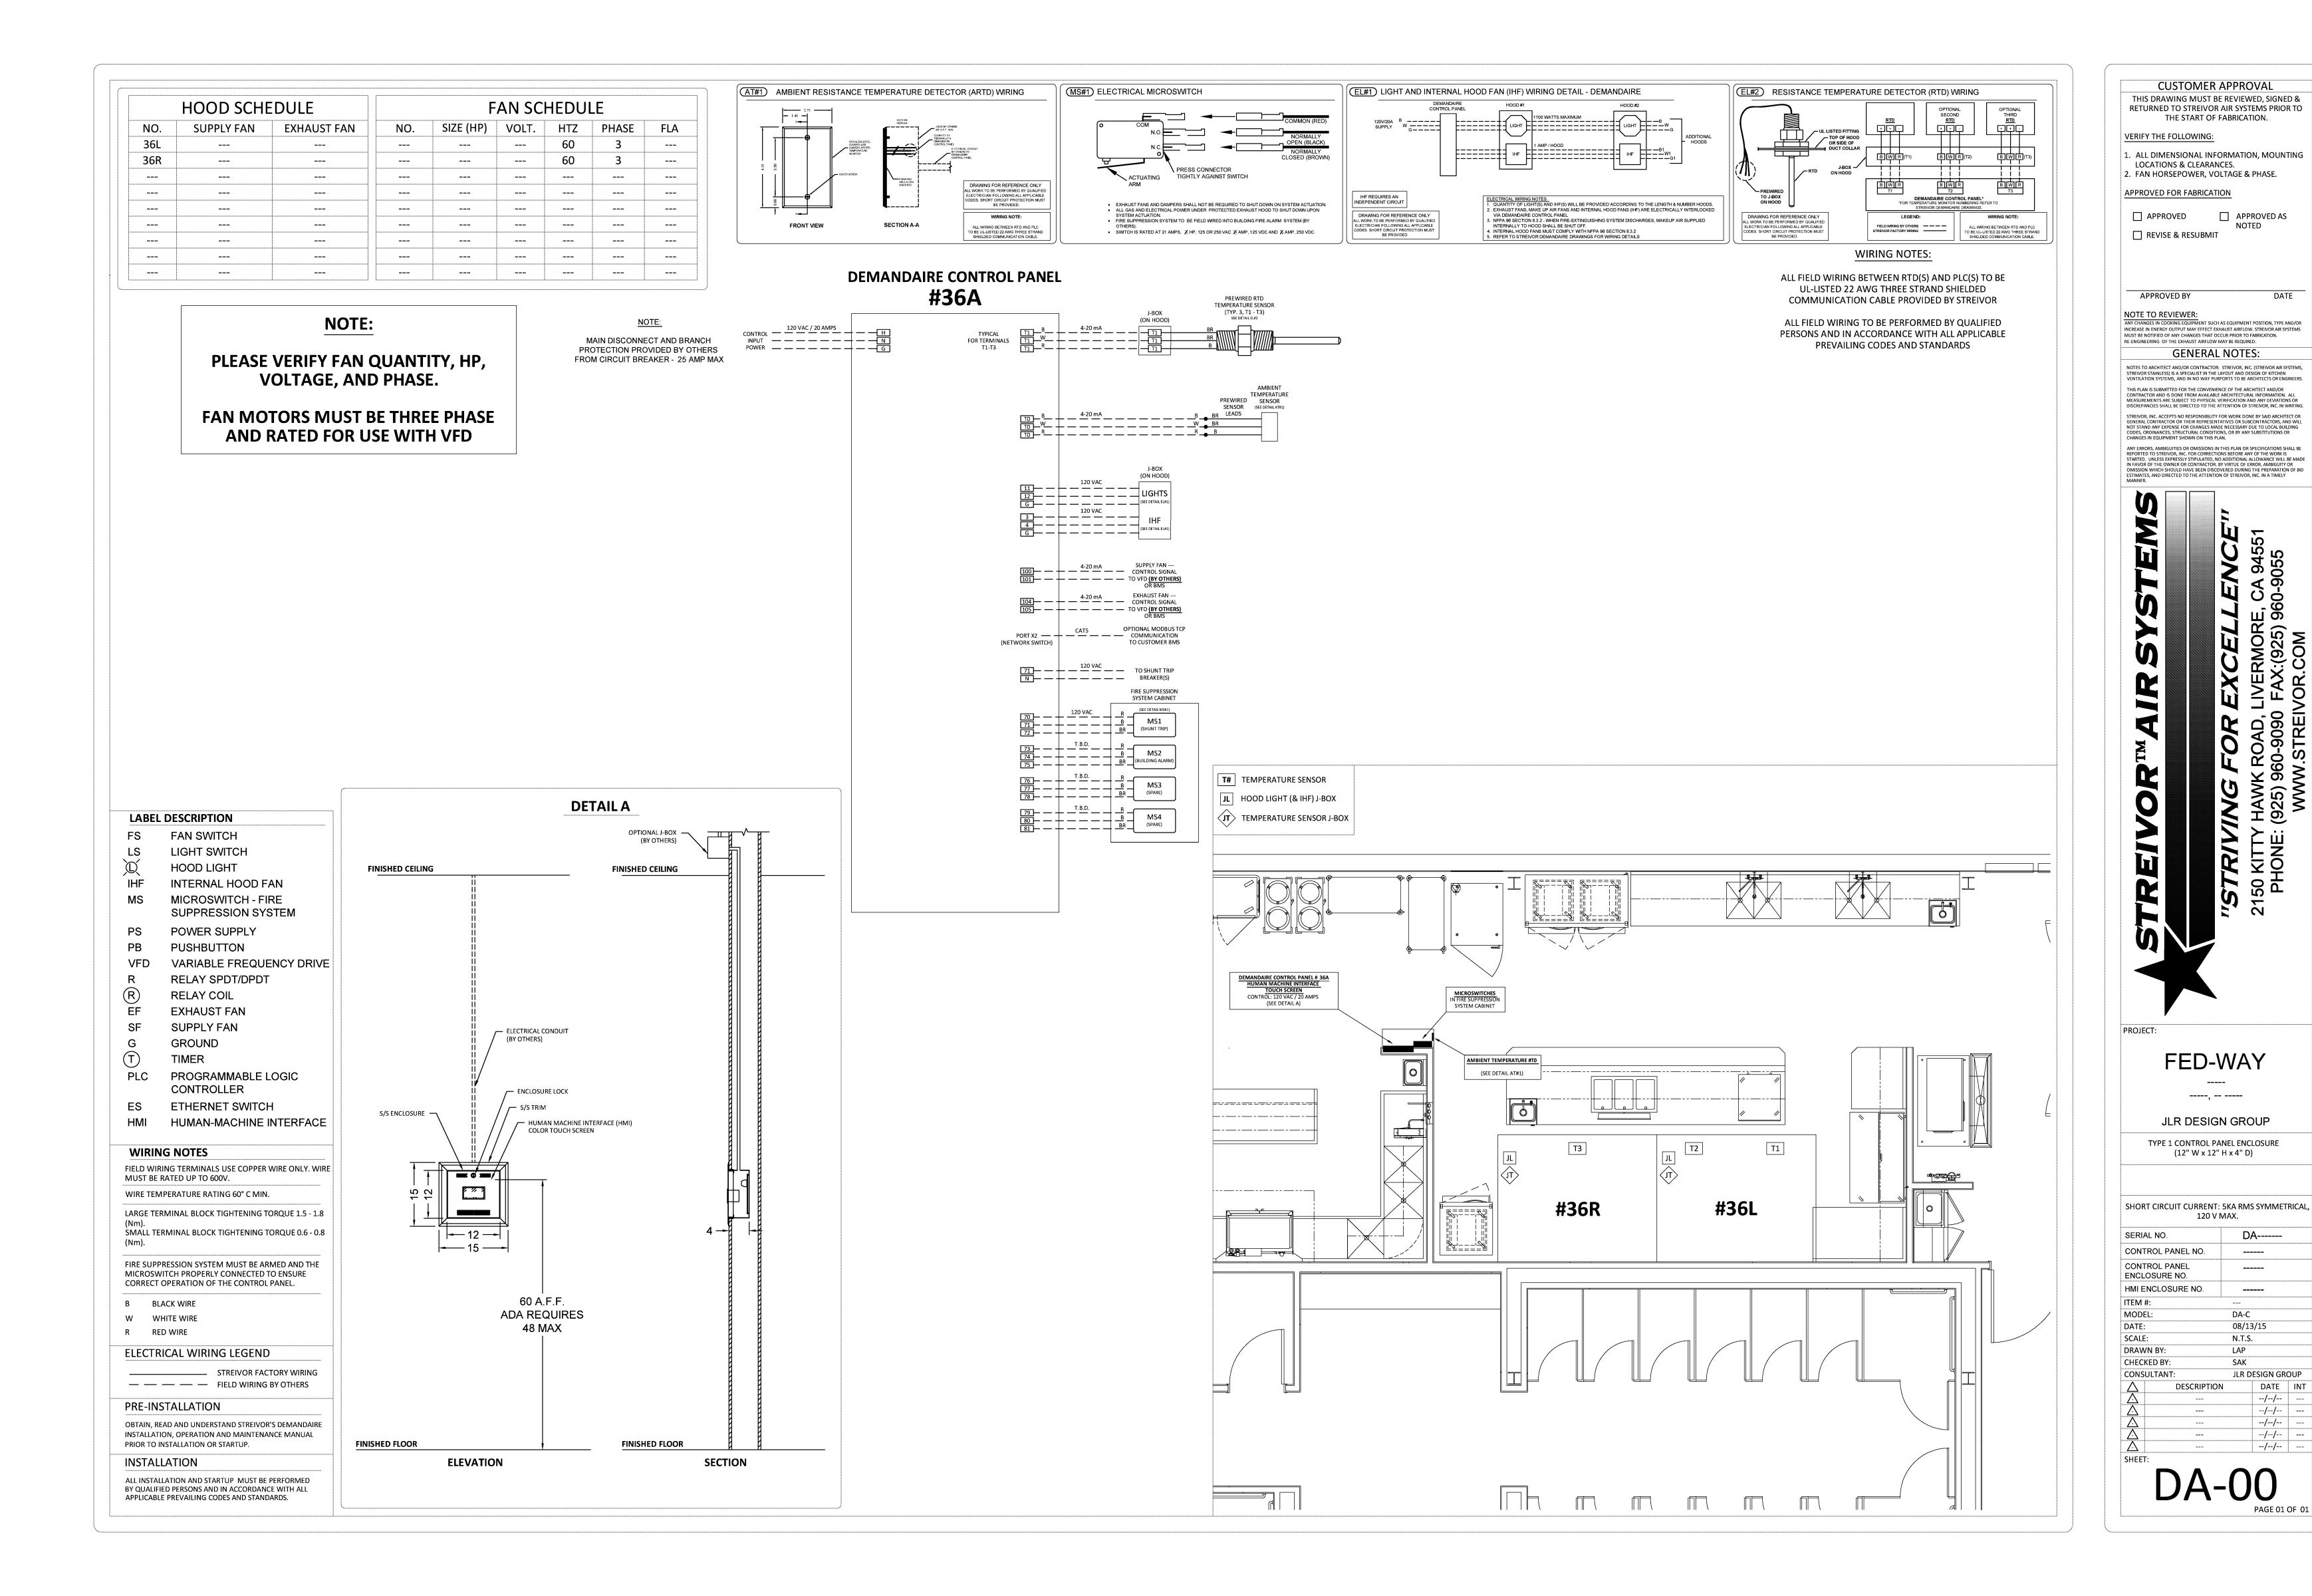

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14 AUGUST 2015

Walk-in Cooler / Freezer Details

FS802